

LATHAN ■ McKEE
A R C H I T E C T S

300 CHASE PARK SOUTH • SUITE 200 • HOOVER, ALABAMA 35244
205-988-9112

ADDENDUM NO. 2

NEW EMA CENTER FOR RUSSELL COUNTY, AL

Architect Job No. 25-13

November 17, 2025

DCM #TBD

BIDS DUE:

Tuesday, December 2, 2025, until

2:00 p.m., local time, held at

Russell County Commission

1000 Broad Street

Phenix City, AL 36867

MANDATORY PRE-BID MEETING:

Wednesday, November 19, 2025, at

10:00 a.m., local time, held at

Russell County Emergency Management Agency / Homeland Security

311 Prentiss Drive

Phenix City, AL 36869

The Plans and Specifications are here by amended. The following supersedes all contrary and/or conflicting information and is made part of the contract documents.

SPECIFICATIONS

1. **REVISED SECTION 08810 – GLASS AND GLAZING** IN ITS ENTIRETY.

DRAWINGS

1. **SHEET A2.1** – REMOVED CASEWORK/FURNITURE FROM DISPATCH 111 AND ADDED A NOTE.
2. **SHEET A5.1** – CHANGED WALL TILE SIZE ON ELEVATIONS 7, 8, 9, 11, 12, 13, 14, 15.
3. **SHEET A6.1** – REPLACE PAGE IN ITS ENTIRETY.
4. **SHEET A6.2** – DELETED DISPATCH 111 ELEVATIONS 5 AND 6- REVISED NUMBERING SEQUENCE.
5. **SHEET A6.3** – REPLACE PAGE IN ITS ENTIRETY.

6. **SHEET A8.1** – BREAKROOM 113 AND DAYROOM 119 REPLACED LVT- 1 WITH LVT-2/ DEPUTY DIRECTOR OFFICE 127 AND DIRECTOR OFFICE 124 REPLACED CPT-2 WITH CPT-1.
7. **SHEET A8.2** – REVISED FINISH SCHEDULE AND REMOVED CWT-3 AND GWT-2.

1.0 - GENERAL

1.1 Scope

The work under this section consists of all glass and glazing.

1.2 Quality

- A. Glazing shall be provided to comply with Table 5.3.1 Building Envelope Requirements - Climate Zone 1 of the Alabama Building Energy Conservation Code, and the 2021 International Building Code.
- B. Glazing for Fire-Rated Door and Window Assemblies: Glazing tested per NFPA 252 and NFPA 257, as applicable, for assemblies complying with NFPA 80 and listed and labeled per requirements of authorities having jurisdiction.
- C. Safety Glazing Products: Comply with size, glazing type, location, and testing requirements of 16 CFR 1201 for Category I and II glazing products, and requirements of authorities having jurisdiction.
- D. Glazing Industry Publications: Comply with glass product manufacturers' recommendations and the following:
 1. GANA Publications: GANA Laminated Division's 'Laminated Glass Design Guide' and GANA's 'Glazing Manual.'
 2. IGMA Publication for Insulating Glass: IGMA TM-3000, 'Glazing Guidelines for Sealed Insulating Glass Units.'
- E. Insulating-Glass Certification Program: Indicate compliance with requirements of Insulating Glass Certification Council on applicable glazing products.

1.3 Samples

Submit for approval samples of each kind of glass required. Each sample shall bear a label indicating the kind and quality of the glass and the manufacturer. **Only 1 sample each is required.**

1.4 Warranty

- A. Warranty for Coated-Glass Products: Manufacturer's standard form, signed by coated-glass product primary manufacturer or manufacturer/fabricator, as applicable, agreeing to replace coated-glass units that display peeling, cracking, and other deterioration in metallic coating under normal use, within 10 years of date of Substantial Completion.
- B. Warranty for Laminated Glass: Manufacturer's standard form, signed by laminated-glass product manufacturer/fabricator, agreeing to replace laminated-glass units that display edge separation, delamination, and blemishes exceeding those allowed by ASTM C 1172, within five years of date of Substantial Completion.
- C. Warranty for Insulating Glass: Manufacturer's standard form, signed by insulating-glass product manufacturer/fabricator, agreeing to replace insulating-glass units that exhibit failure of hermetic seal under normal use evidenced by the obstruction of vision by dust, moisture, or film on interior surfaces of glass, within 10 years of date of Substantial Completion.

D. **Installer's Warranty:** Form acceptable to Owner, signed by glass product Installer, agreeing to replace glass products that deteriorate, or that exhibit damage or deterioration of glass or glazing products due to faulty installation, within 2 years of date of Substantial Completion.

2.0 - PRODUCTS

2.1 Manufacturer

Glass products shall be as manufactured by Vitro Architectural Glass., Guardian Industries, Inc., or Pre-approved equal. Laminated pattern glass shall be as manufactured by North American Glass Fabrication. Fire-rated, safety-rated wired glass shall be manufactured by Technical Glass Products, Pilkington or SaftiFirst.

2.2 Materials

Glass shall be as defined in, and in accordance with Code of Federal Regulations 16 CFR 1201 - Safety Standard for Architectural Glazing Materials.

- A. Compound for face glazing, or where shown or indicated as compound shall be an oleo-resinous knife grade elastic glazing compound such as Tremco's Trem-glaze, Pecora's M-242, or Dap-1012.
- B. Sealant where shown or indicated shall be Tremco "Mono," Dow Corning 780, or GE's construction sealant.
- C. Tape where shown or indicated shall be Tremco's 440 Tape, Curtis 606 Tape, or Warflex's "Sealing Tape."
- D. Neoprene setting blocks as approved by glass manufacturer Shore "A" Hardness approximately 70 to 90.
- E. Neoprene spacer shims as approved by glass manufacturer Shore "A" Hardness approximately 40 to 60.
- F. Neoprene glazing beads as approved for aluminum store front and doors.
- G. Color of compound, sealant, tape, etc. shall be as selected.
- H. Glare reducing glass shall be 1/4" thick Solargray, Solargreen, or Solarbronze as selected.
- I. Glare reducing Tempered Safety glass shall be 1/4" thick Solargray, Solargreen, or Solarbronze as selected. When multiple small glass panes are used in the same door or sidelight, provide one (1) only Decal and furnish certificate verifying the use of Safety Glass in other panels.
- J. Interior Tempered Safety Glass shall meet 16CFR1201 Test Requirements, Cat. 1 and/or Cat. 2 as applicable. Etch label and furnish certificate verifying the use of Tempered Safety Glass.
- K. Interior laminated pattern safety glass shall be two (2) layers 1/4" thick tempered safety glass with adhesive sheets and light frost decorative interlayer with pattern as indicated.
- L. Fire safety glass shall be 5/16" thick clear laminated fire rated and impact safety rated glass. Approved equal to Pilkington Fire-Lite Plus or SaftiFirst SuperLite and

shall meet impact safety rating 16CFR1201 (Cat.1) if less than 9 sq. ft. and (Cat. 2) if greater than 9 sq. ft. Provide with label at all rated doors and frames..

- M. Polished plate glass mirrors shall be 1/4" copper back, moisture resistant with ground edges and beveled face grooving. Secure with adhesive and clips. Sizes and locations indicated.
- N. 1" insulating Glass - Pre-assembly Low-E unit consisting of 1/4" float glass exterior lite, 1/2" dehydrated air space and clear 1/4" float glass with Low-E interior lite meeting performance requirement for Class A or Class B Accelerated Test as specified in ASTM E744 with no visible fog. Match color on metal spacer to glazing frame. As selected by Architect. Provide minimum SHGC of .25.
 - 1. Solarban 60 Solar Gray + Clear
- O. Spandrel Glass - 1/4" thick, float glass with the opacifying coating on the number 2 (inboard) face. Temper or heat strengthen in accordance with the current Glass Tempering Association, Engineered Standard Manual. Opacifying coating shall be Opaci-Coat-300 Coating shall be Silicone water based glastomer with a min/max wet thickness of 8 mils. (0.008") and a protective coating of silicone rubber a minimum wet thickness of 13 mils (0.0013"). Color as selected by Architect. Provide minimum SHGC of .25.
 - 1. Solarban 60 Solar Gray + Clear "SolarGray Series"

3.0 - EXECUTION

3.1 Preparation

- A. Immediately prior to glazing, all surfaces shall be wiped clean and free of protective coatings, moisture, and dust. All glazing shall be done when the temperature is 35° F or above.
- B. All sash shall be checked prior to glazing to make certain that the opening is square, plumb, and secured in order that uniform face and edge clearances are maintained. Inspect all butt and miter joints. If these joints are open, they shall be sealed with sealant prior to glazing. All ventilators shall be properly adjusted. Maintain 1/8" minimum bed clearance between glass and sash on both sides.
- C. All glass indicated in non-rated doors shall be tempered with etched label.
- D. All glass indicated in rated doors shall be fire safety glass with etched label.

3.2 Setting




- A. Glazing preparation and procedures shall be as outlined in the Glazing Manual of the Flat Glass Jobbers Association.
- B. Glass shall be set without springing, and with an equal bearing the entire width and length of each piece.
- C. The actual sizes required shall be determined by measuring the frames to receive the glass. All glass shall be factory labeled.

- D. Glass shall be properly cut and set in accordance with the best practice of the trade.
- E. Center glass in glazing rabbet to maintain recommended clearances at perimeter for expansion and contraction, each face of glass.

3.3 **Protection**
Immediately after installation, a marker letter shall be placed upon each pane of glass for protection against careless breakage. All broken, cracked, scratched, or otherwise damaged glass shall be replaced.

3.4 **Cleaning**
A. Upon completion of the project, all glass shall have paint, dirt, and other stains removed; glass shall then be washed clean and polished.
B. Labels on glass shall not be removed until final approval is obtained, and glass is ready for cleaning.

END OF SECTION

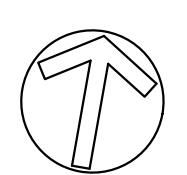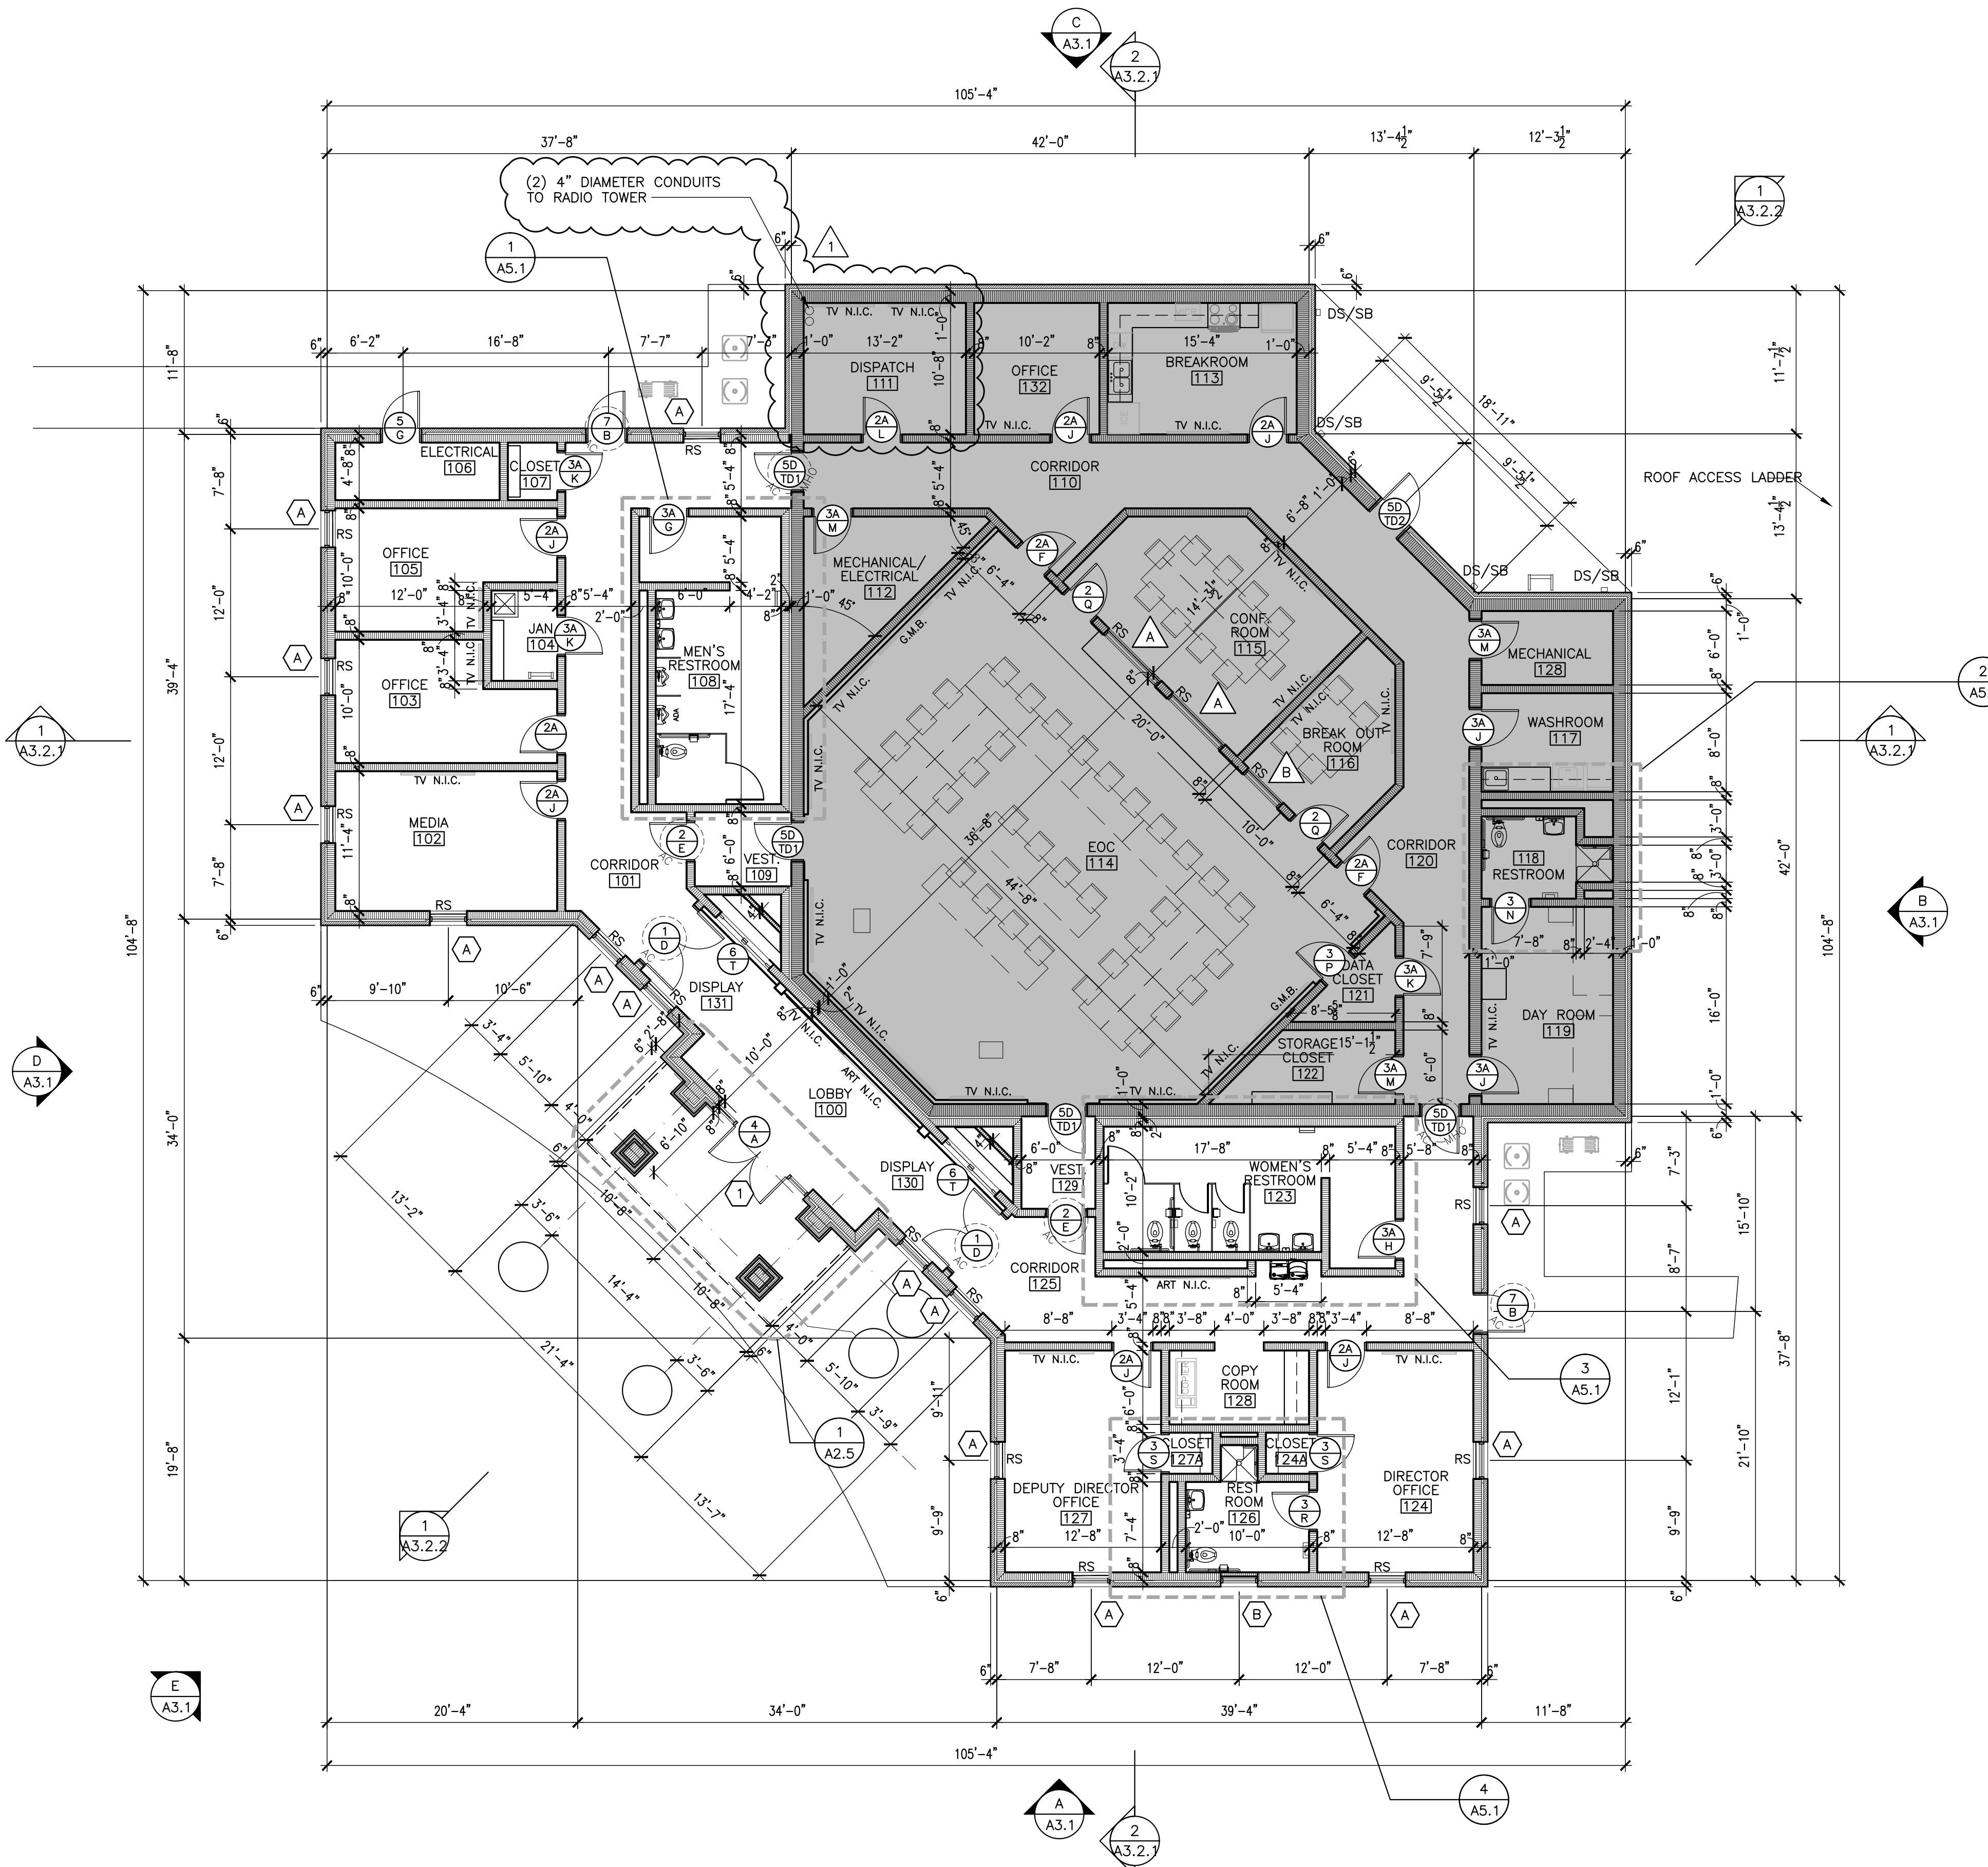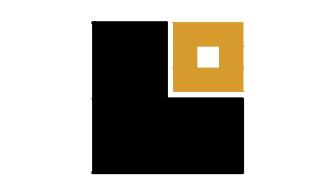

1 OVERALL FLOOR PLAN


SCALE: 1/8" = 1'-0"

DOOR PLACEMENT LEGEND		
FLUSH FRAME	18" MIN.	18" MIN.
CENTERED FRAME	EQ	EQ
OFFSET FRAME	8"	12" MIN.

DOOR FIRE RATING LEGEND		
DOOR TYPE	(2)	NO RATING
DOOR TYPE + A	(2A)	20 MINUTE RATING
DOOR TYPE + B	(2B)	45 MINUTE RATING
DOOR TYPE + C	(2C)	60 MINUTE RATING
DOOR TYPE + D	(2D)	90 MINUTE RATING
DOOR TYPE + E	(2E)	180 MINUTE RATING

SYMBOLS LEGEND		
DOOR TYPE	DOOR TYPE	DOOR TYPE
DOOR RATING	DOOR RATING	DOOR RATING
HARDWARE SYMBOL	HARDWARE SYMBOL	HARDWARE SYMBOL
OPEN	A	A
CLOSED	C	C
HALF OPEN	B	B
HALF CLOSED	D	D
ACCESS CONTROL	E	E
MANUAL HOLD OPEN	F	F
SECT. MARK	G	G
ROUGH IN ELECTRICAL	H	H
ELEV. MARK	I	I
Sheet Number	J	J
ELEV. MARK	K	K
Sheet Number	L	L
INTERIOR ELEVATION	M	M
NEW DOOR AND SWING	N	N
EWC	O	O
TB	P	P
MB	Q	Q
FEC	R	R
A200	S	S
EJ	T	T
FE	U	U
CJ	V	V
RS	W	W


SHEET TITLE:
OVERALL FLOOR PLAN

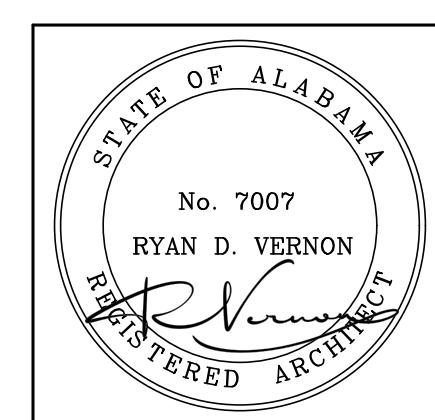

PROJ. MGR.: R. VERNON
DRAWN: ELM
DATE: 10-24-2025
REVISIONS
1 11.18.25 ADD #2

JOB NO. 25-13
SHEET NO:
A2.1
2 OF 24
0 1" 2"

WALL TYPE LEGEND		
EXTERIOR WALL	NEW 4" BRICK VENEER W/ AIR SPACE AND RIGID INSULATION ON REINFORCED CMU WITH DAMP-PROOFING, PROVIDE BRICK WALL TIES @ 16" O.C.	
EXTERIOR WALL (STORM SHELTER)	NEW 4" BRICK VENEER W/ AIR SPACE AND RIGID INSULATION ON REINFORCED 12" REINFORCED CMU WITH DAMP-PROOFING, PROVIDE BRICK WALL TIES @ 16" O.C., SEE STRUCTURAL	
CMU WALL	8" OR 12" CONCRETE MASONRY WALL. SEE PLAN FOR WALL WIDTH CHANGES SEE LIFE SAFETY PLAN FOR FIRE RATING	
CMU WALL	8" OR 12" CONCRETE MASONRY WALL. WITH 3-5/8" METAL STUDS AT 16" O.C. WITH 5/8" GYPSUM BOARD	
CMU WALL	8" OR 12" CONCRETE MASONRY WALL. WITH 5/8" GYPSUM BOARD LAMINATED TO CMU	
CMU WALL (STORM SHELTER)	12" REINFORCED CONCRETE MASONRY WALL AT STORM SHELTER, SEE STRUCTURAL	
1 HOUR CMU WALL	FIRE RATED 8" OR 12" CONCRETE MASONRY WALL. SEE LIFE SAFETY PLAN FOR UL DESIGN	
2 HOUR CMU WALL	FIRE RATED 8" OR 12" CONCRETE MASONRY WALL. SEE LIFE SAFETY PLAN FOR UL DESIGN	
3 HOUR CMU WALL	FIRE RATED 8" OR 12" CONCRETE MASONRY WALL. SEE LIFE SAFETY PLAN FOR UL DESIGN	
4 HOUR CMU WALL	FIRE RATED 8" OR 12" CONCRETE MASONRY WALL. SEE LIFE SAFETY PLAN FOR UL DESIGN	
SOUND ATTENUATION PARTITION	8" OR 12" CONCRETE MASONRY WALL WITH SOUND ATTENUATION	

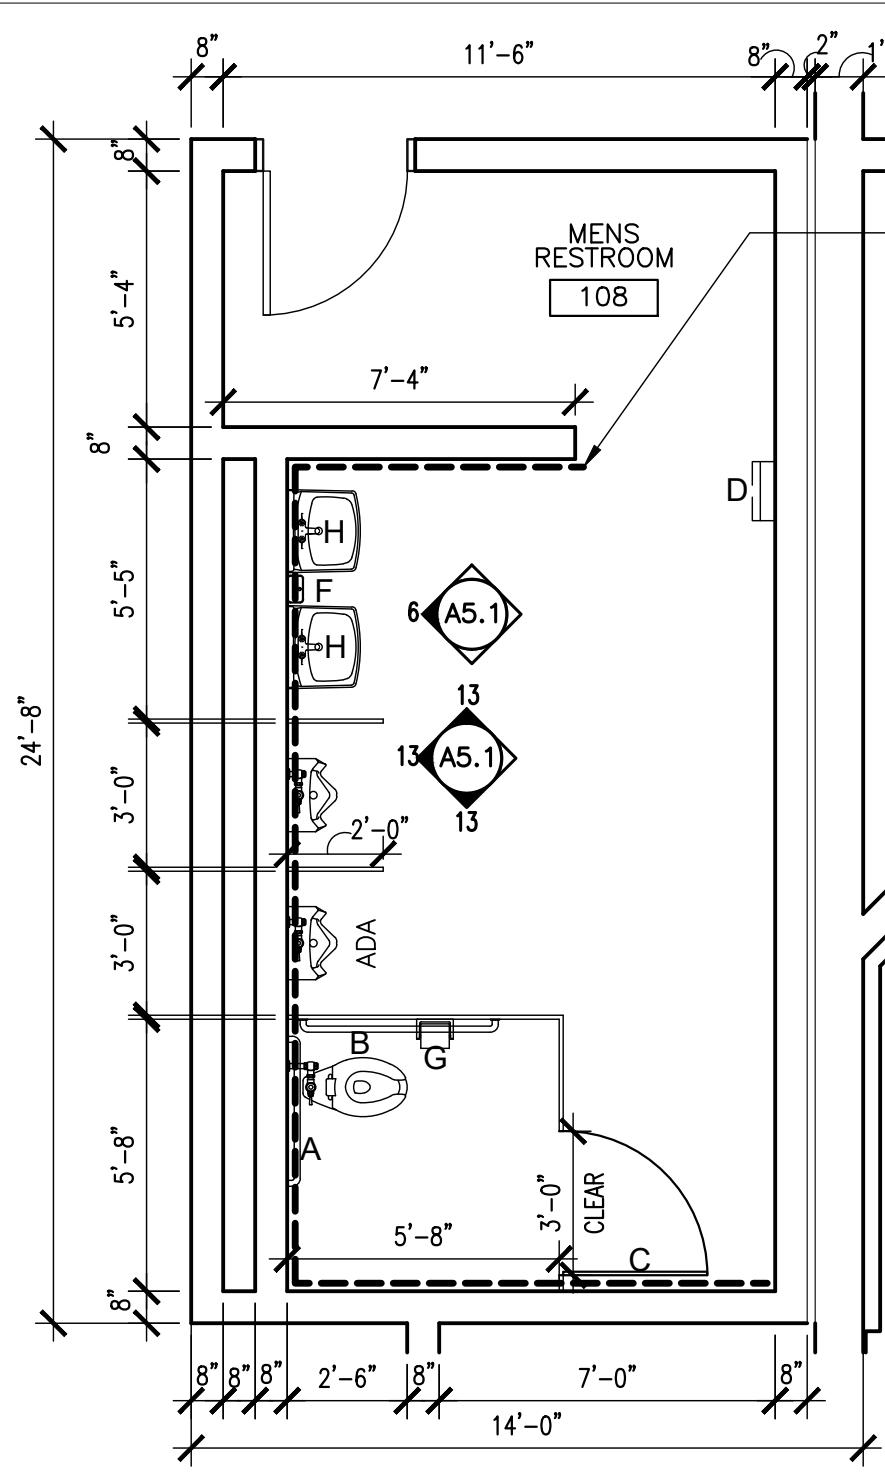


**1 ENLARGED
TOILET PLAN** @ MEN'S 108

**2 ENLARGED
TOILET PLAN** @ RESTROOM 118


**3 ENLARGED
TOILET PLAN** @ WOMEN'S 123

**4 ENLARGED
TOILET PLAN** @ RESTROOM 126


**5 INTERIOR
ELEVATION** @ JAN 104

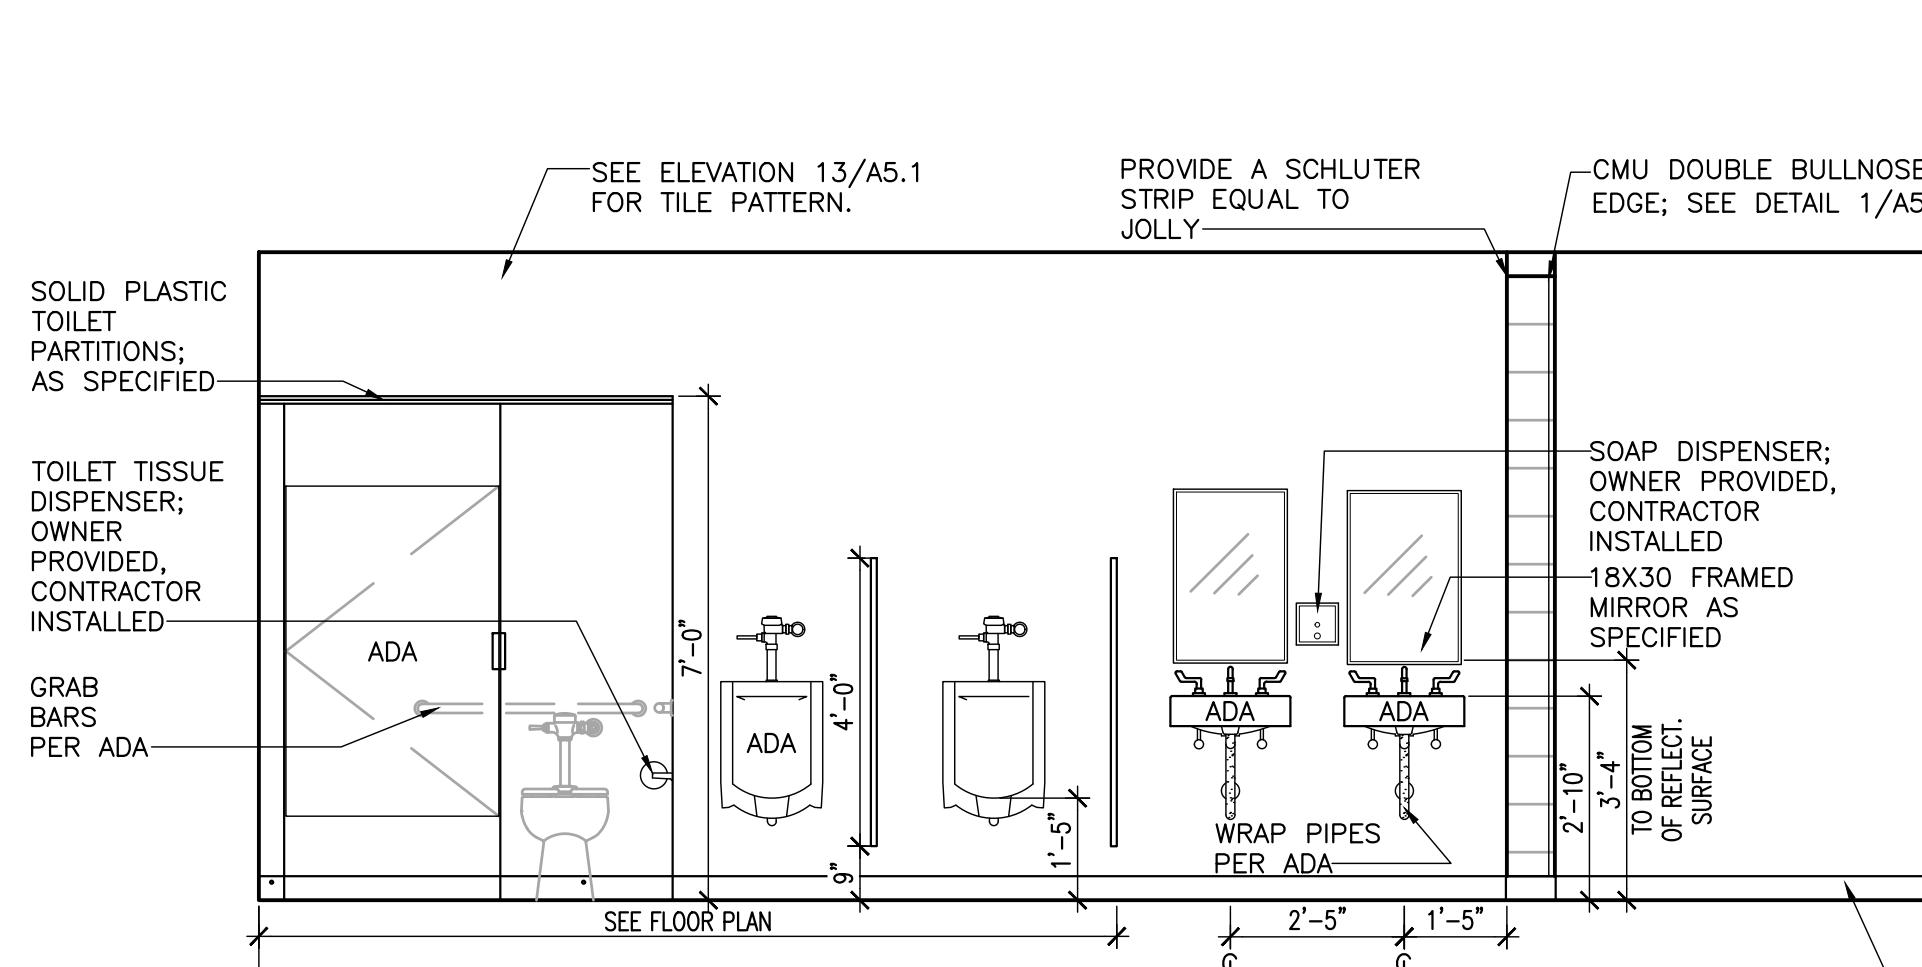


**6 INTERIOR
ELEVATION** @ MEN'S 108

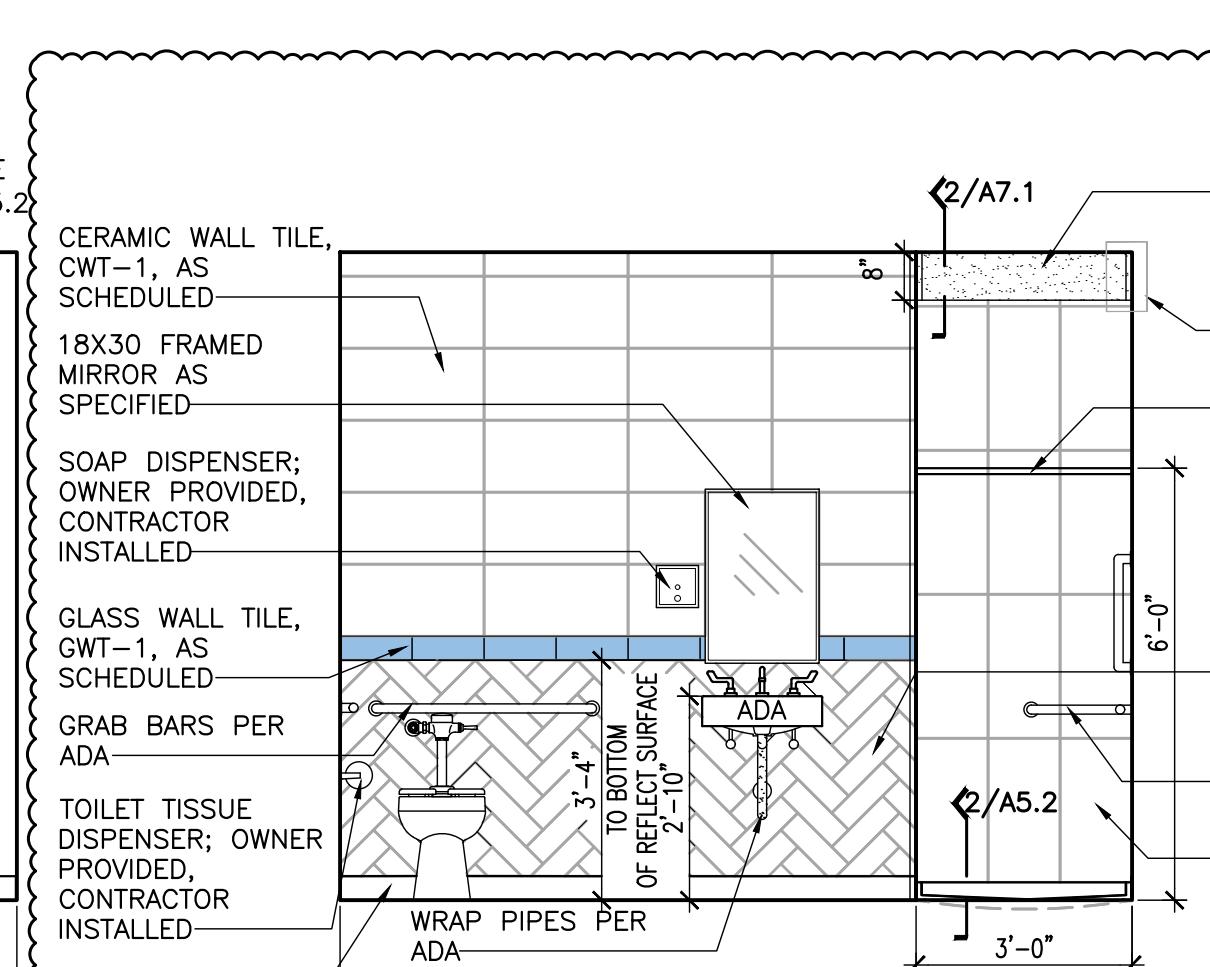


**7 INTERIOR
ELEVATION** @ RESTROOM 118

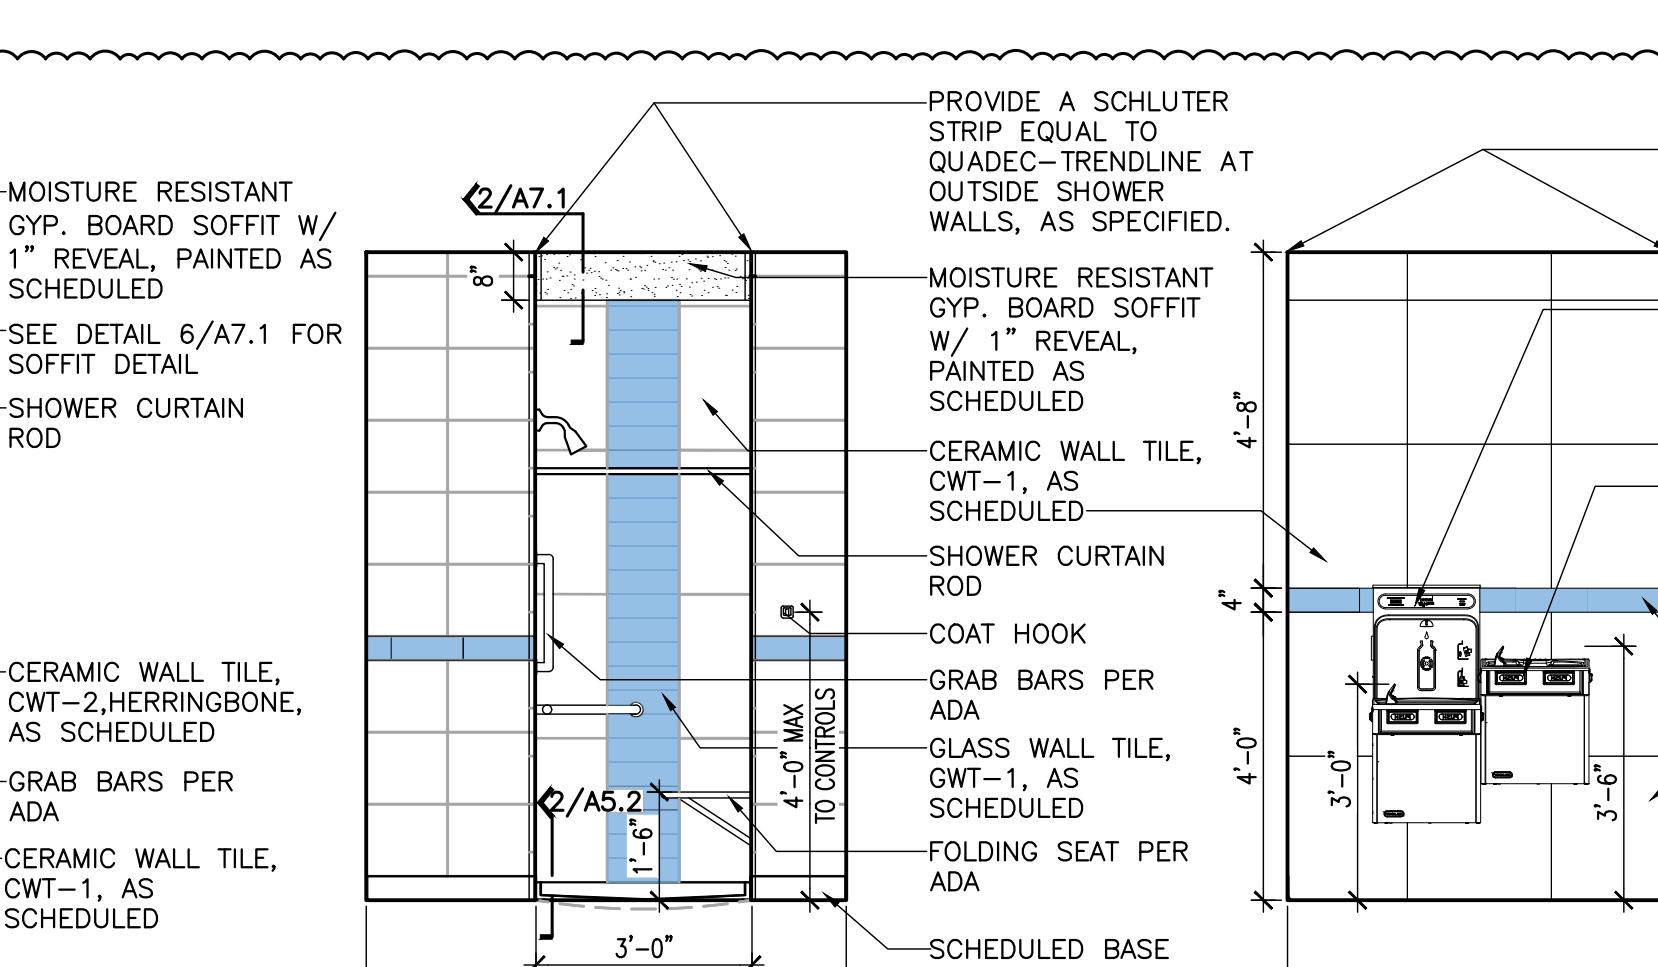


**8 INTERIOR
ELEVATION** @ RESTROOM 118

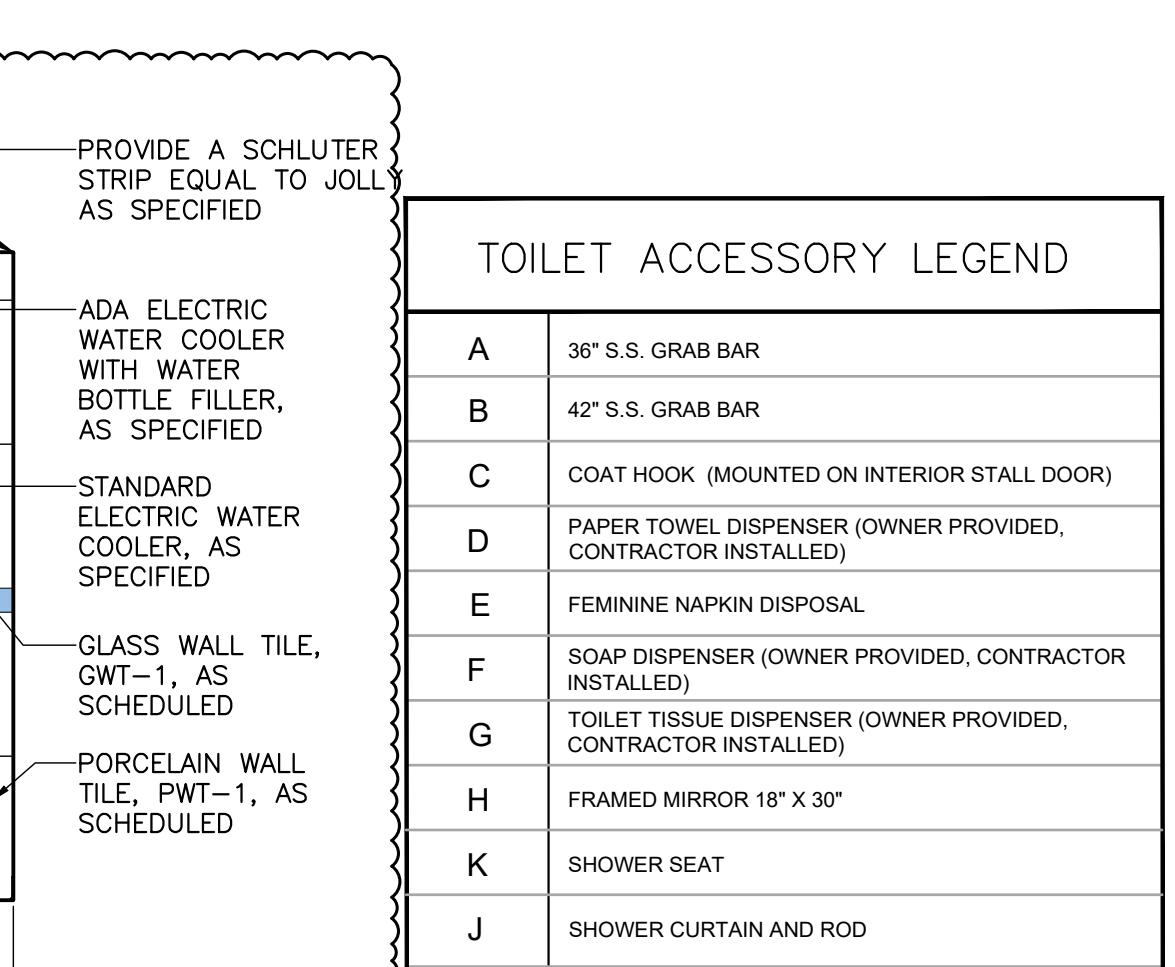


**9 INTERIOR
ELEVATION** @ EWC CORRIDOR 125

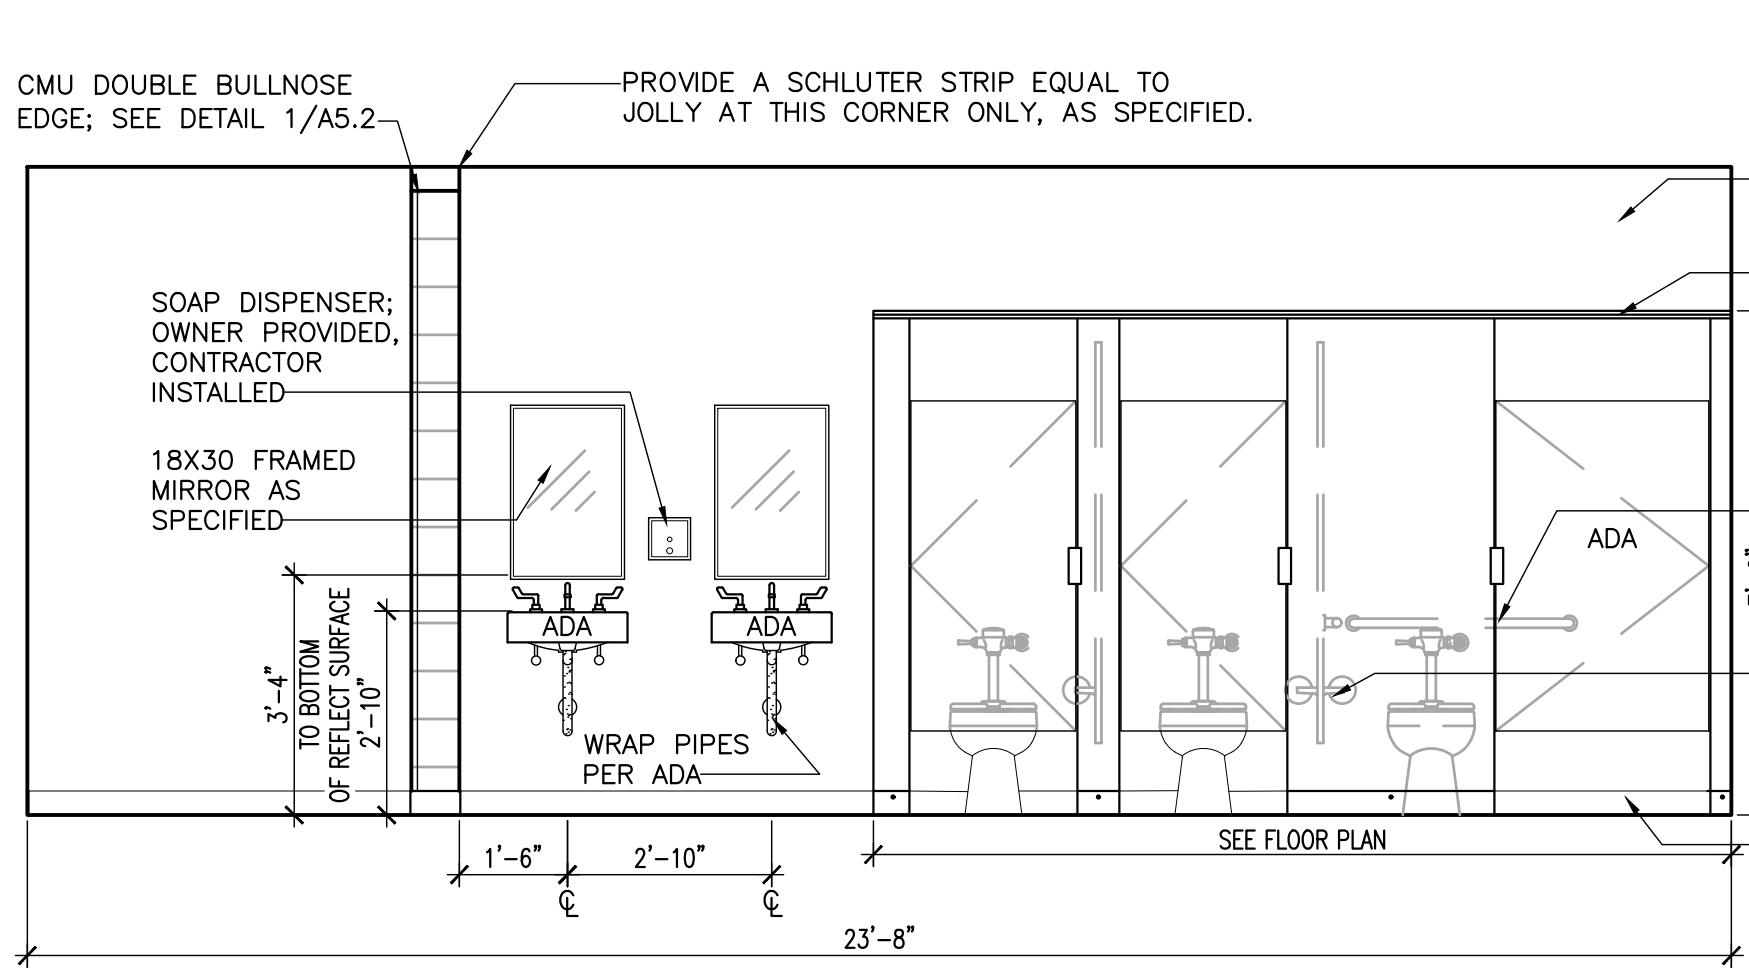


**10 INTERIOR
ELEVATION** @ WOMEN'S 123

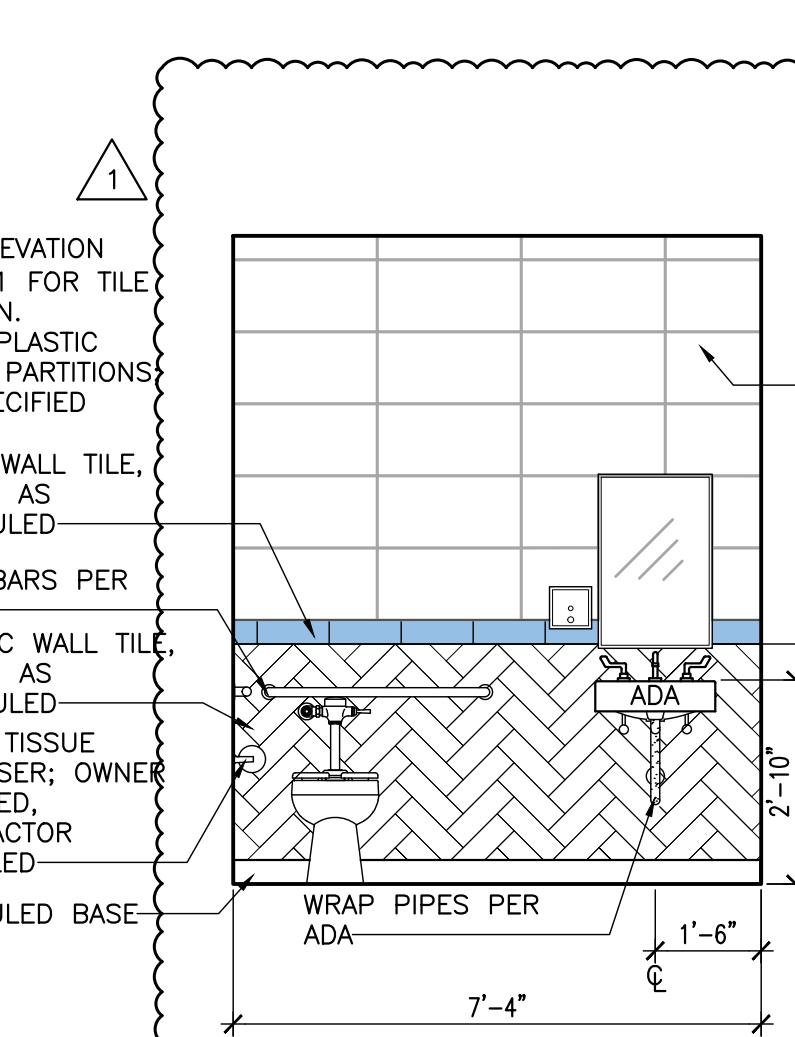

**11 INTERIOR
ELEVATION** @ RESTROOM 126

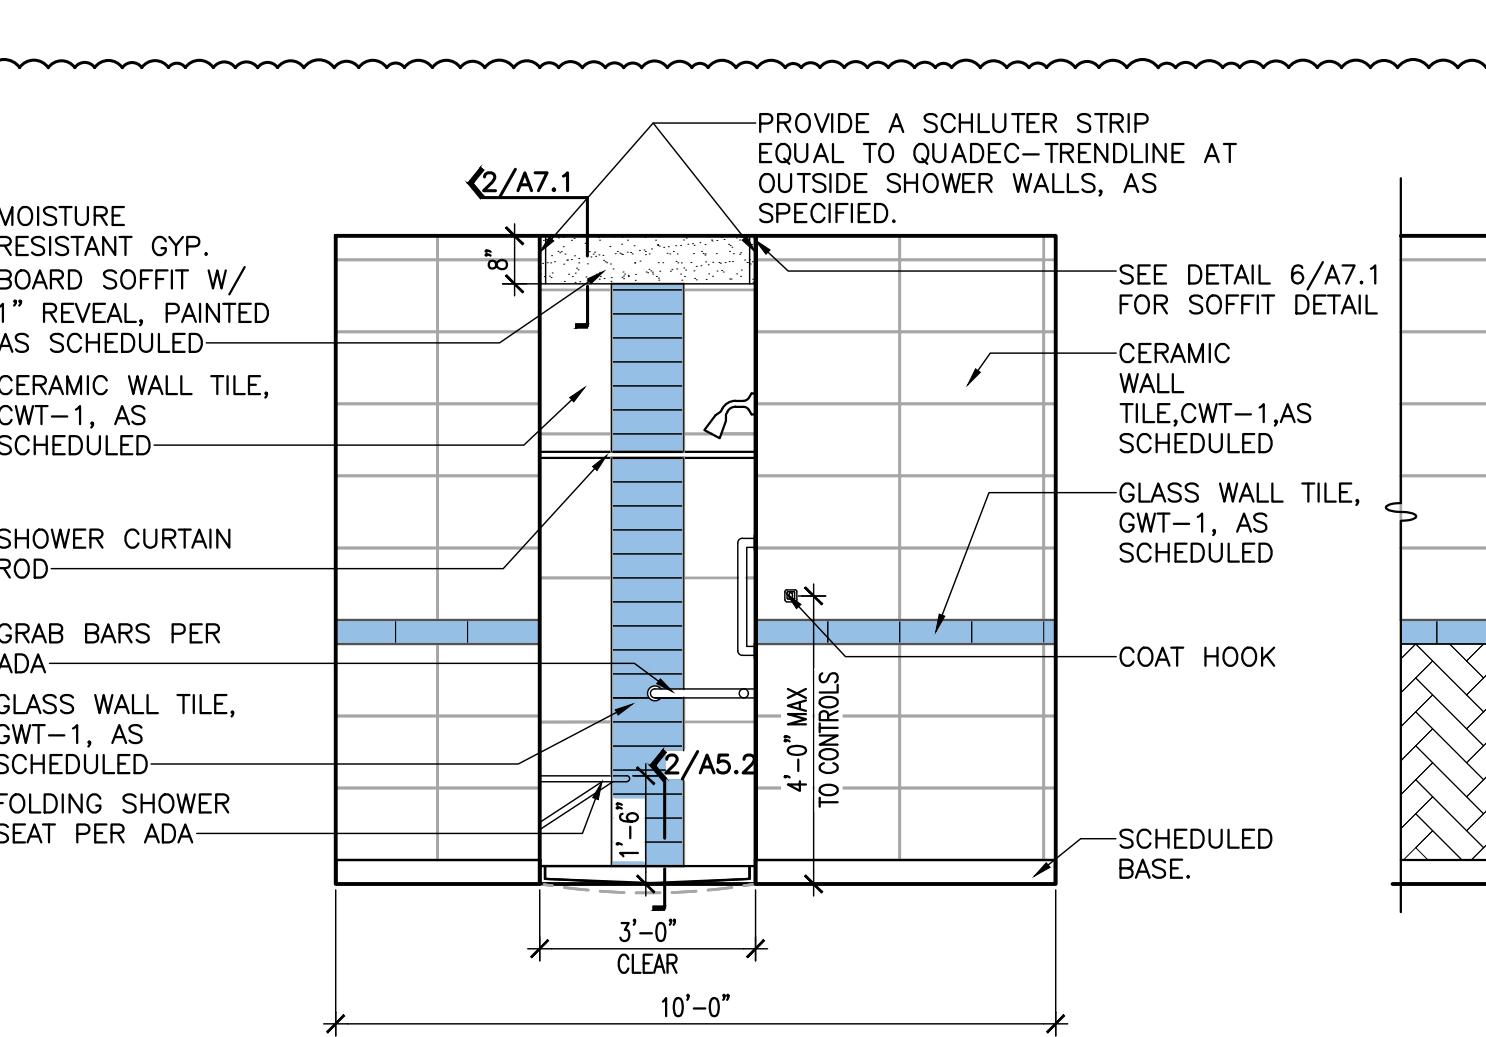


**12 INTERIOR
ELEVATION** @ RESTROOM 126

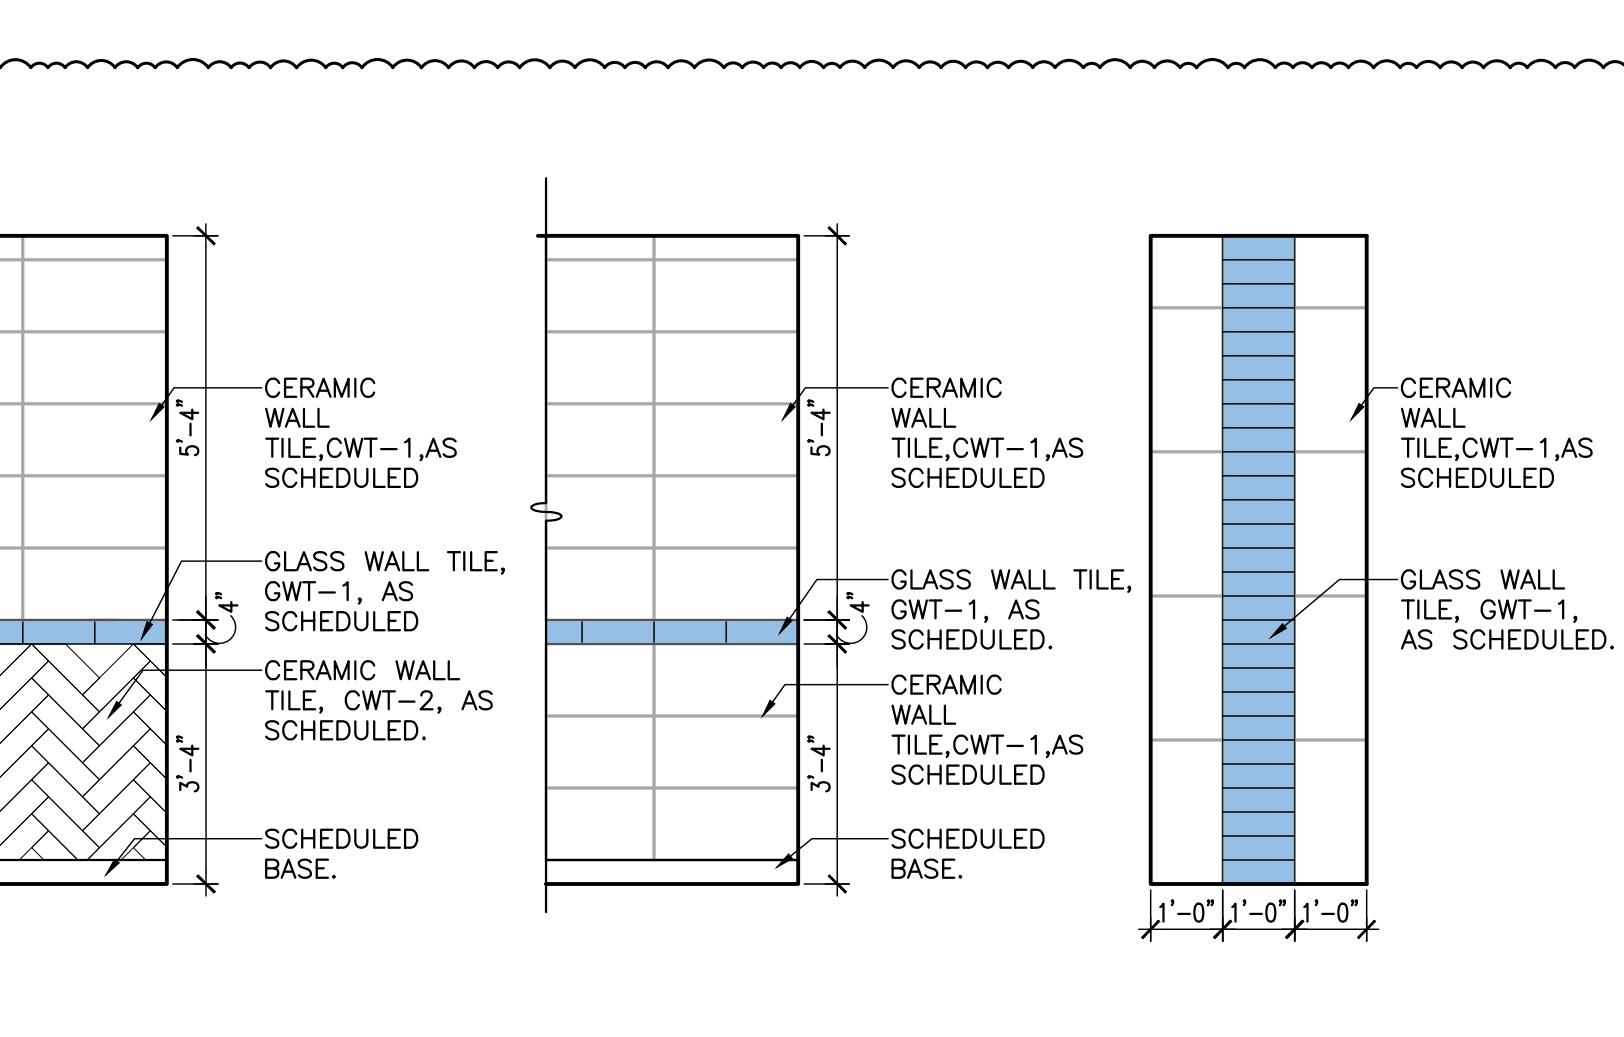

13 INT.ELEV. @ RESTROOM 118
TYPICAL TILE PATTERN

14 INT.ELEV. @ RESTROOM 126
TYPICAL TILE PATTERN



15 INT.ELEV. @ RESTROOM 126
TYPICAL TILE PATTERN

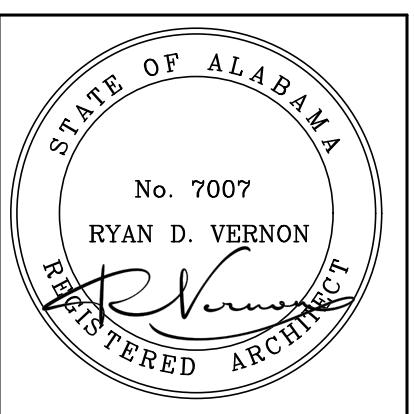

PROJ. MGR.: R. VERNON
 DRAWN: LKB
 DATE: 10-24-2025
 REVISIONS
 1 11.18.25 ADD #2



JOB NO. 25-13
 SHEET NO:
A5.1
 13 OF 24

0 1 2
 TYPICAL TILE PATTERN IN
 RESTROOM 118 AND RESTROOM
 126

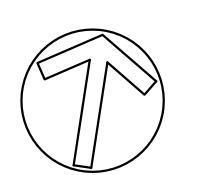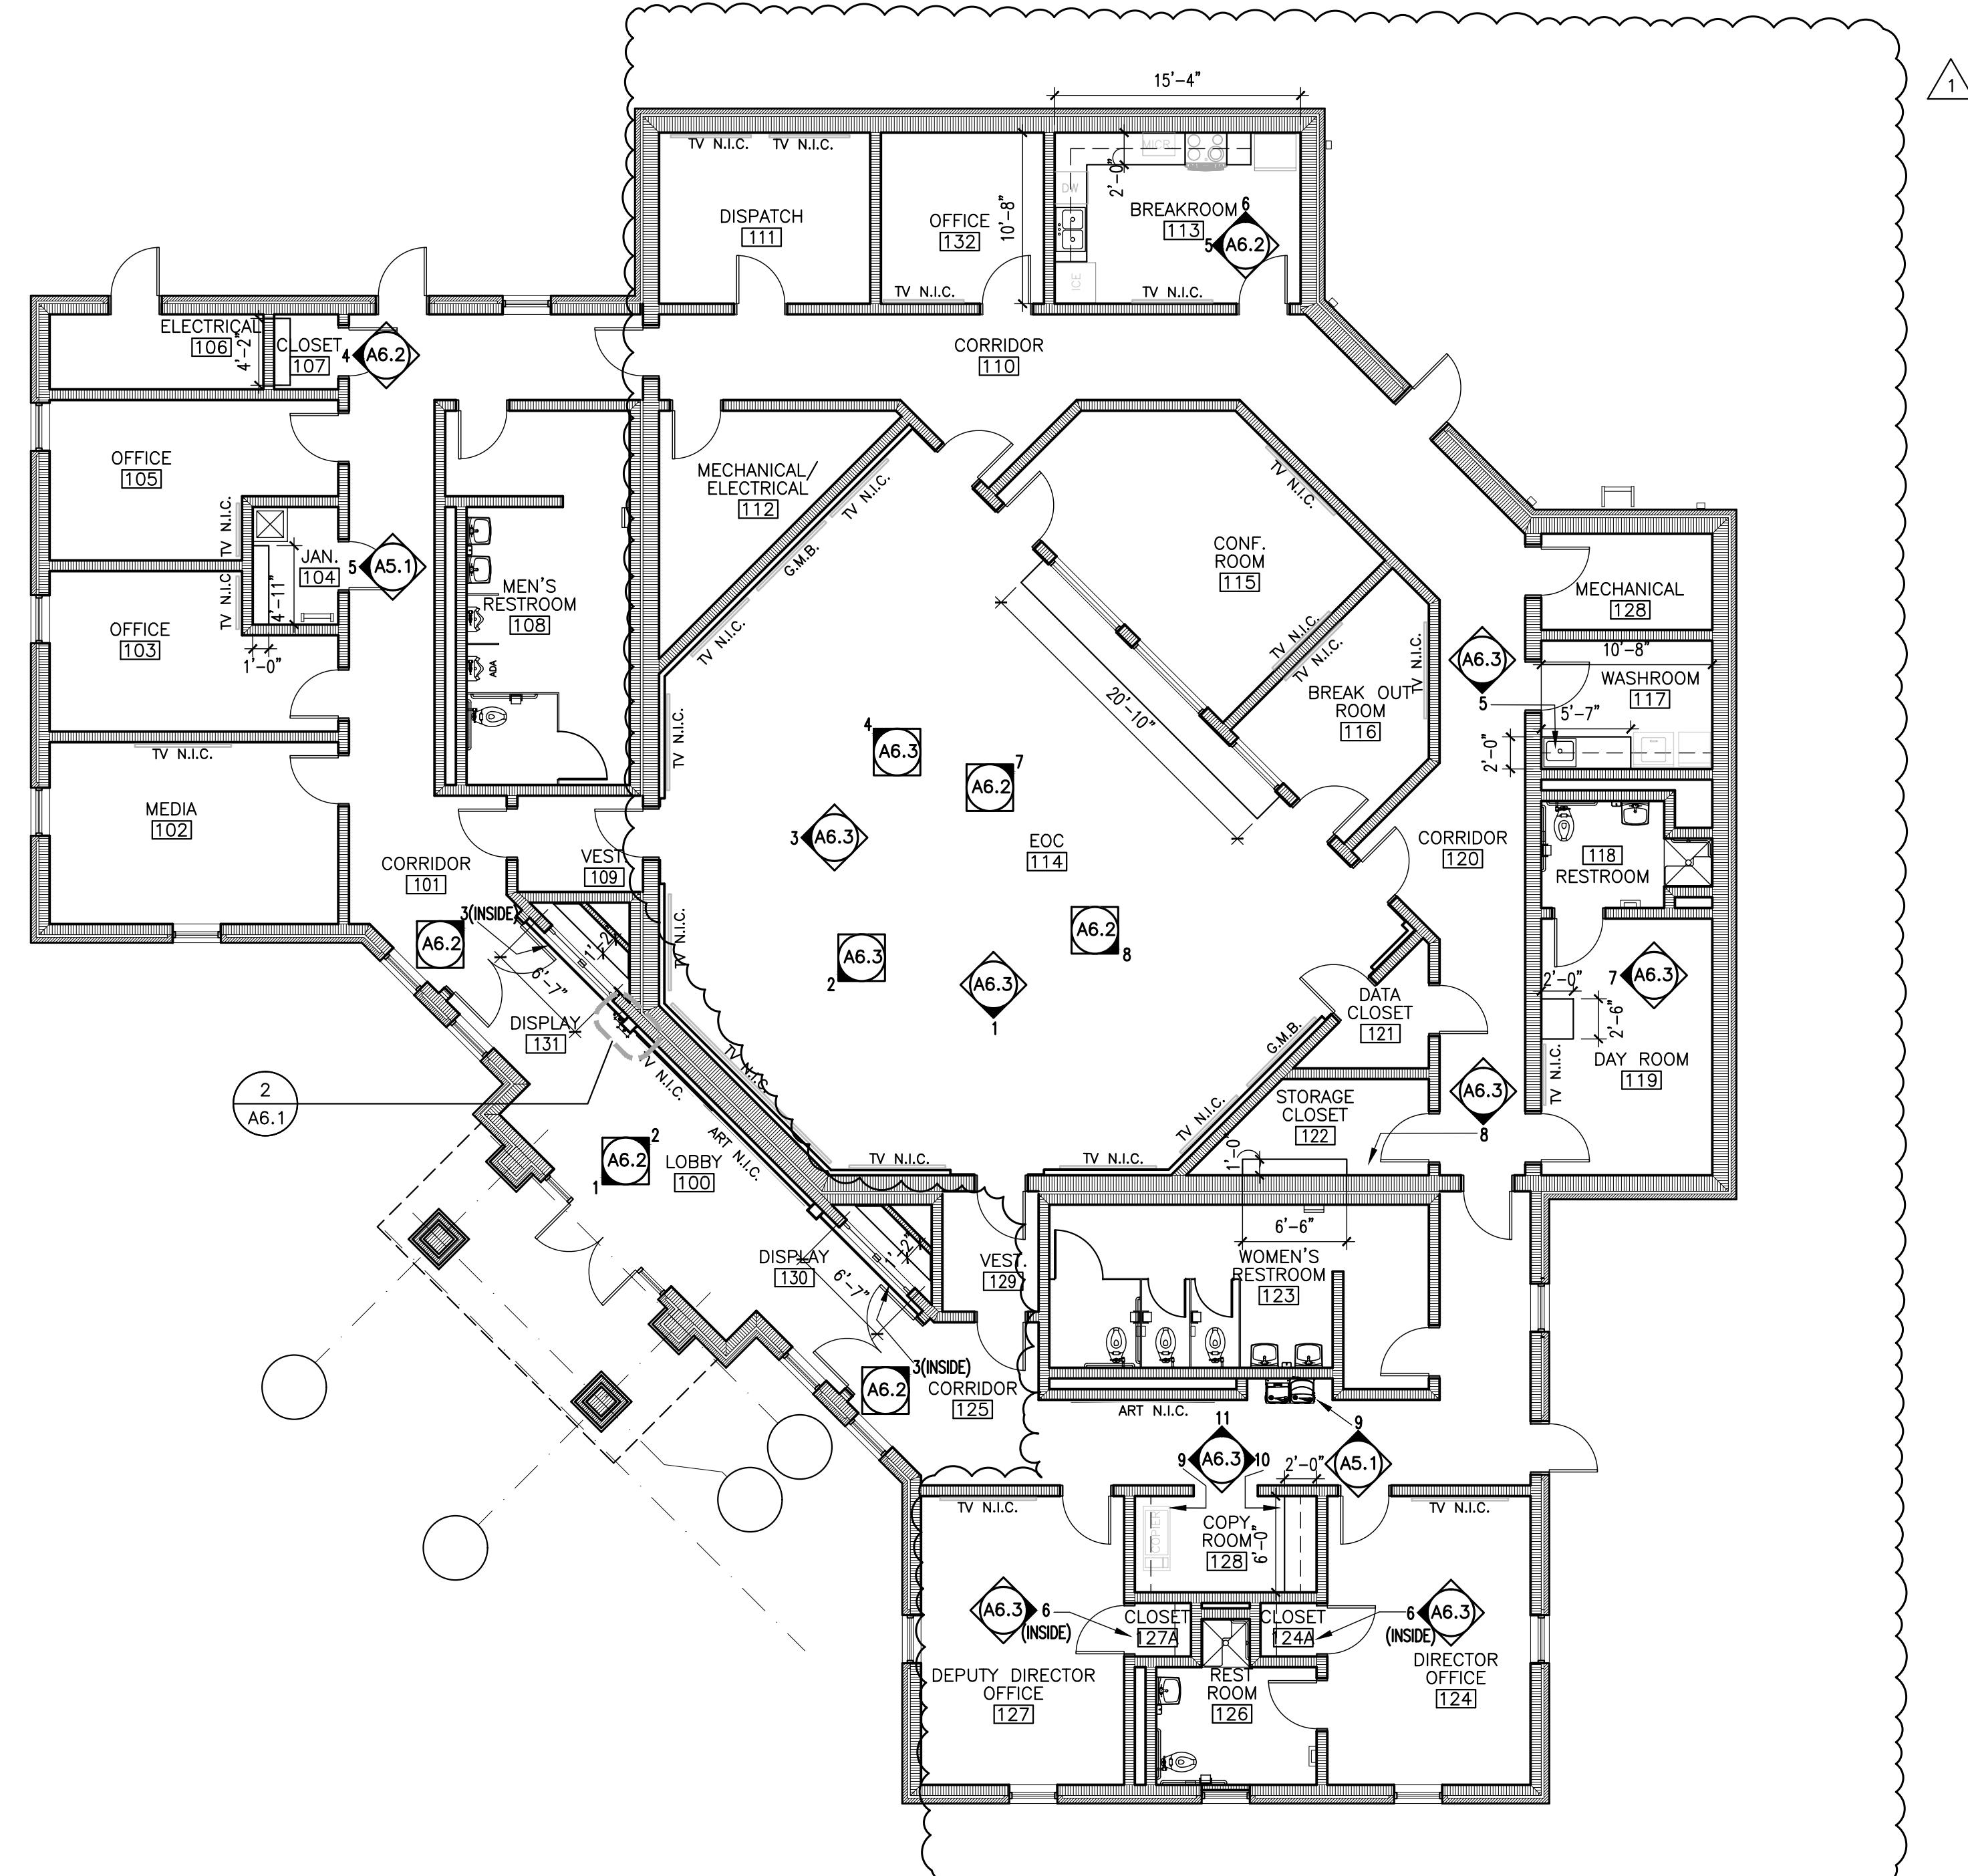

1 CASEWORK PLAN

SCALE: 1/8" = 1'-0"

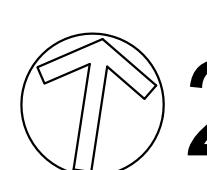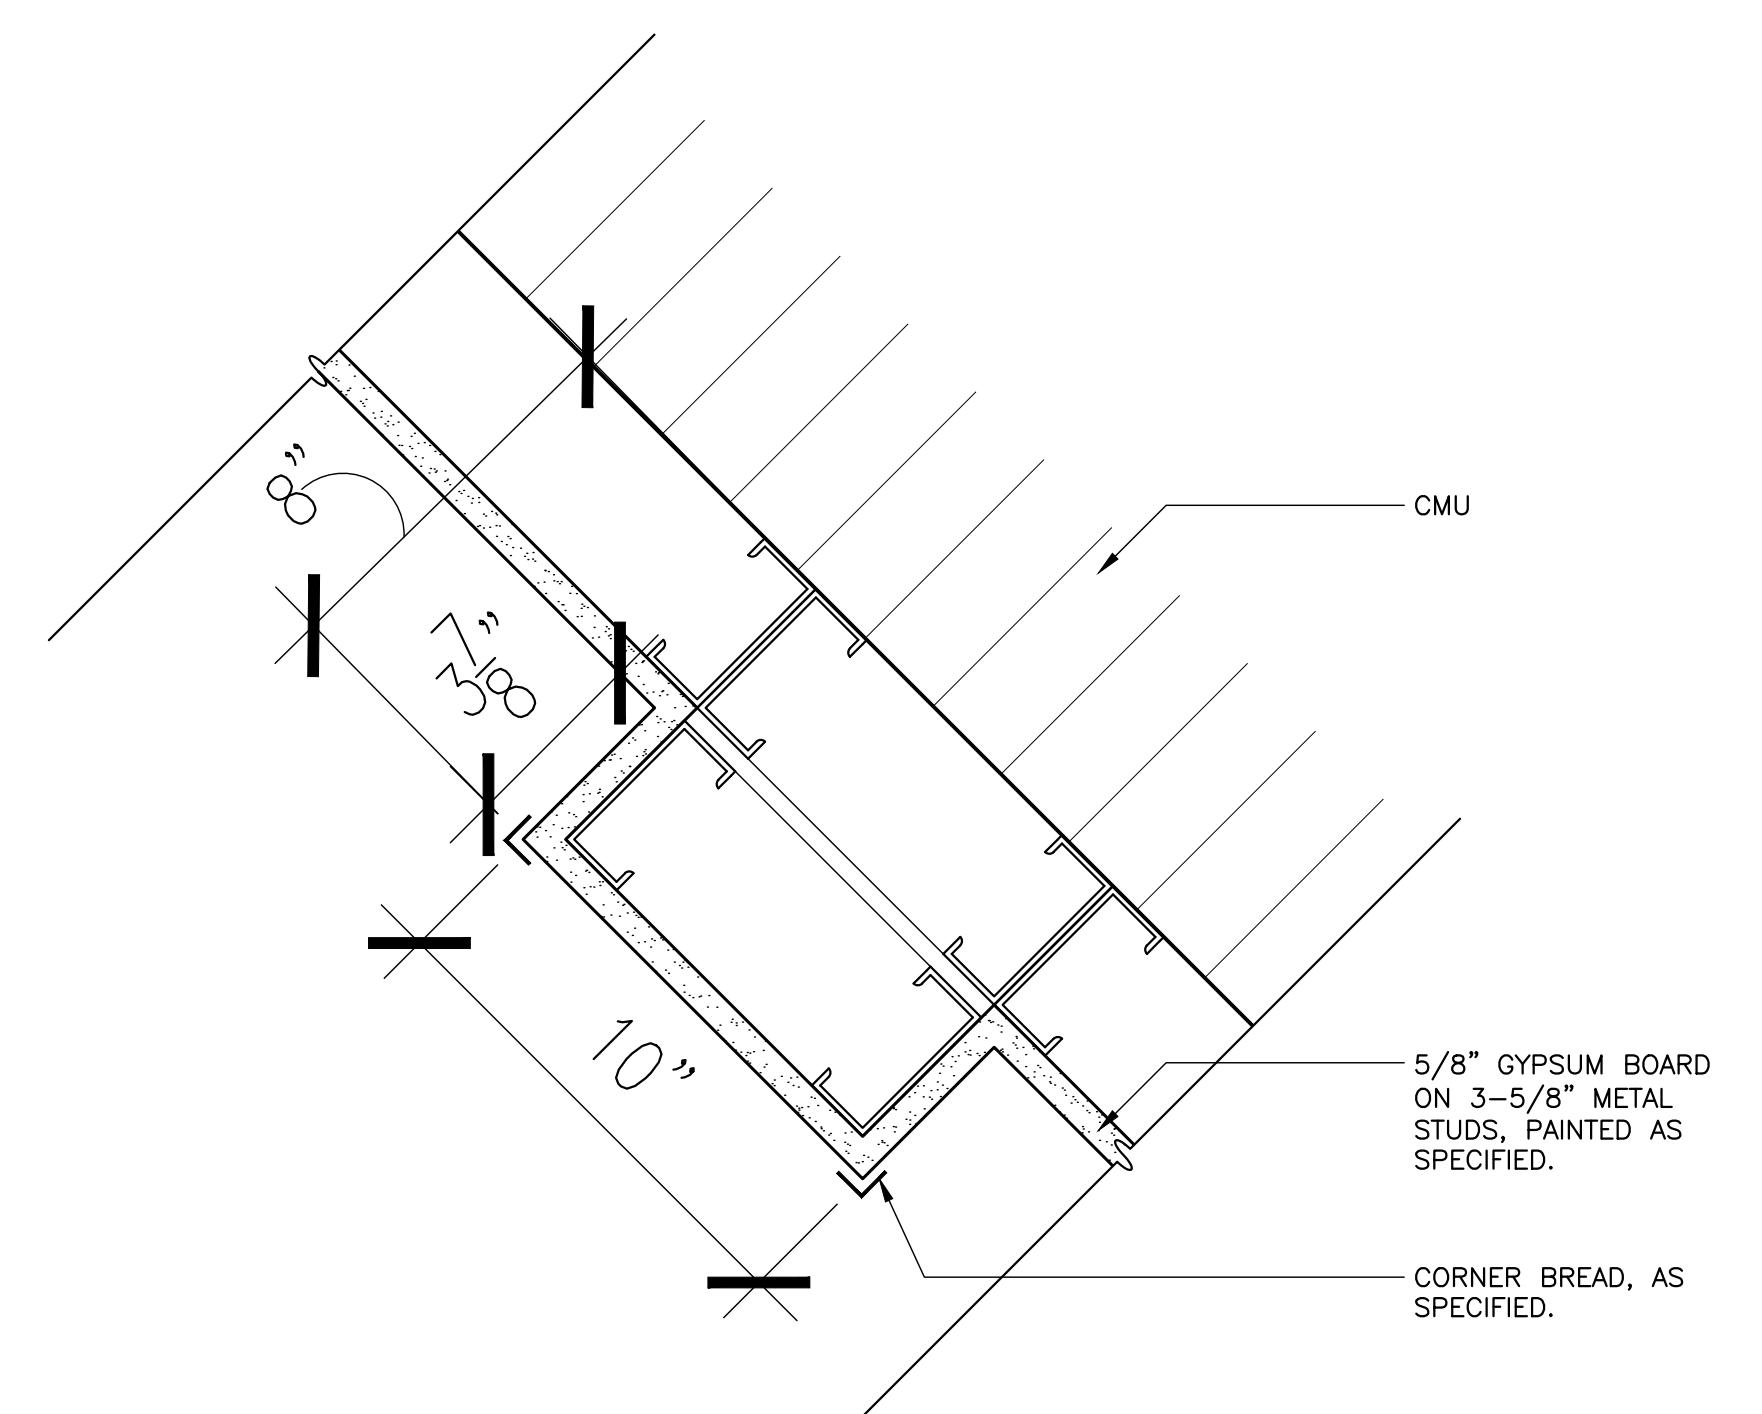


2 ENLARGED PLAN DETAIL [®] LOBBY PILASTER

SCALE: 3" = 1'-0"

NEW EMA CENTER FOR
RUSSELL COUNTY, ALABAMA
5TH STREET SOUTH, PHENIX CITY AL 36869
RUSSELL COUNTY COMMISSION

SHEET TITLE:
CASEWORK PLAN AND DETAIL

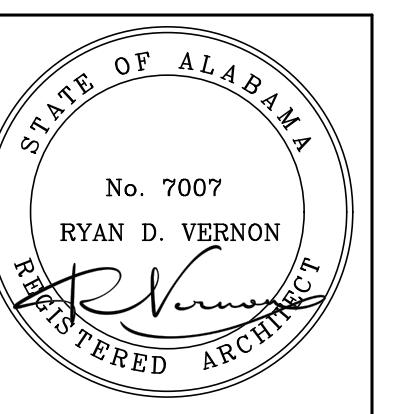

PROJ. MGR.: R. VERNON
DRAWN: LKB

DATE: 10-24-2025
REVISIONS


1 11.18.25 ADD #2

JOB NO. 25-13
SHEET NO:

A6.1


15 OF 24

0 1" 2"

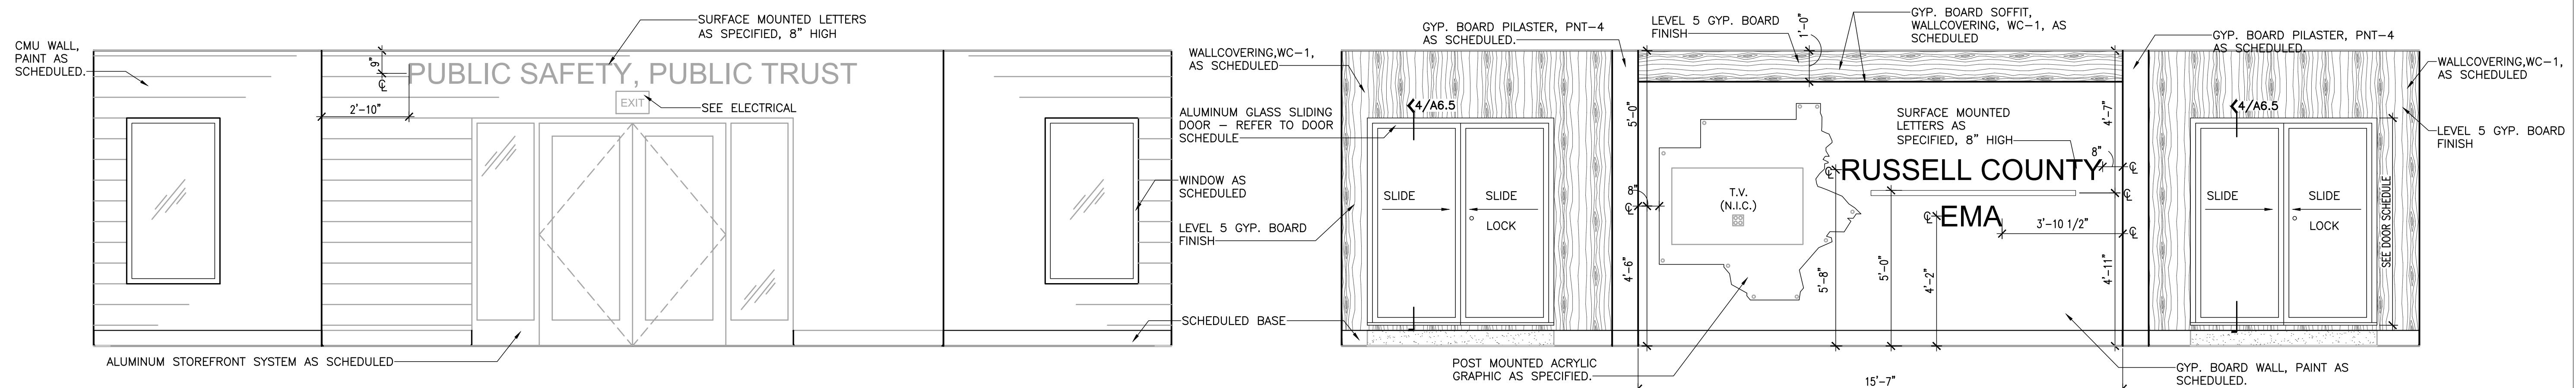

INTERIOR ELEVATION 1 @ LOBBY 100
SCALE: 3/8" = 1'-0"




INTERIOR ELEVATION 2 @ LOBBY 100
SCALE: 3/8" = 1'-0"

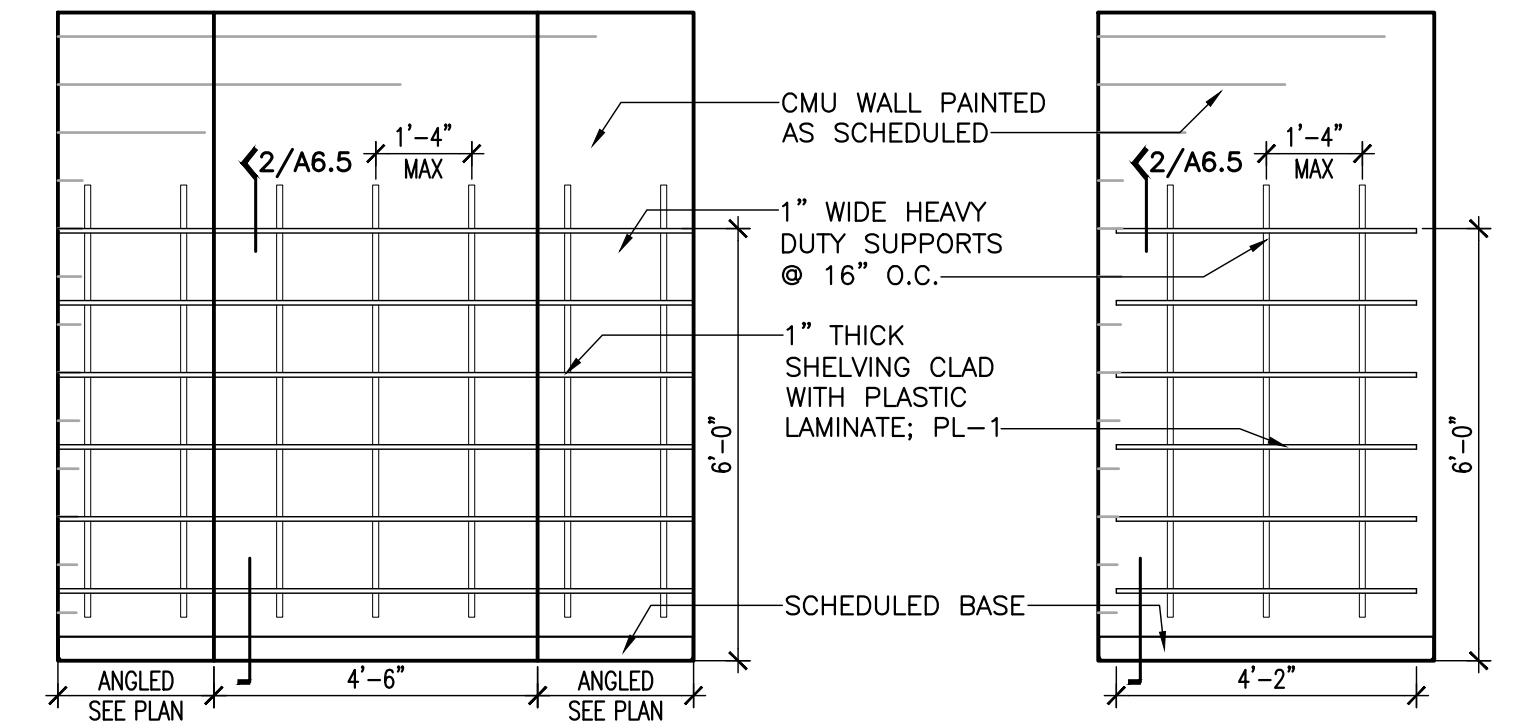


INTERIOR ELEVATION 4 @ CLOSET 107
SCALE: 3/8" = 1'-0"

INTERIOR ELEVATION 5 @ BREAK ROOM 113
SCALE: 3/8" = 1'-0"

INTERIOR ELEVATION 6 @ BREAK ROOM 113
SCALE: 3/8" = 1'-0"

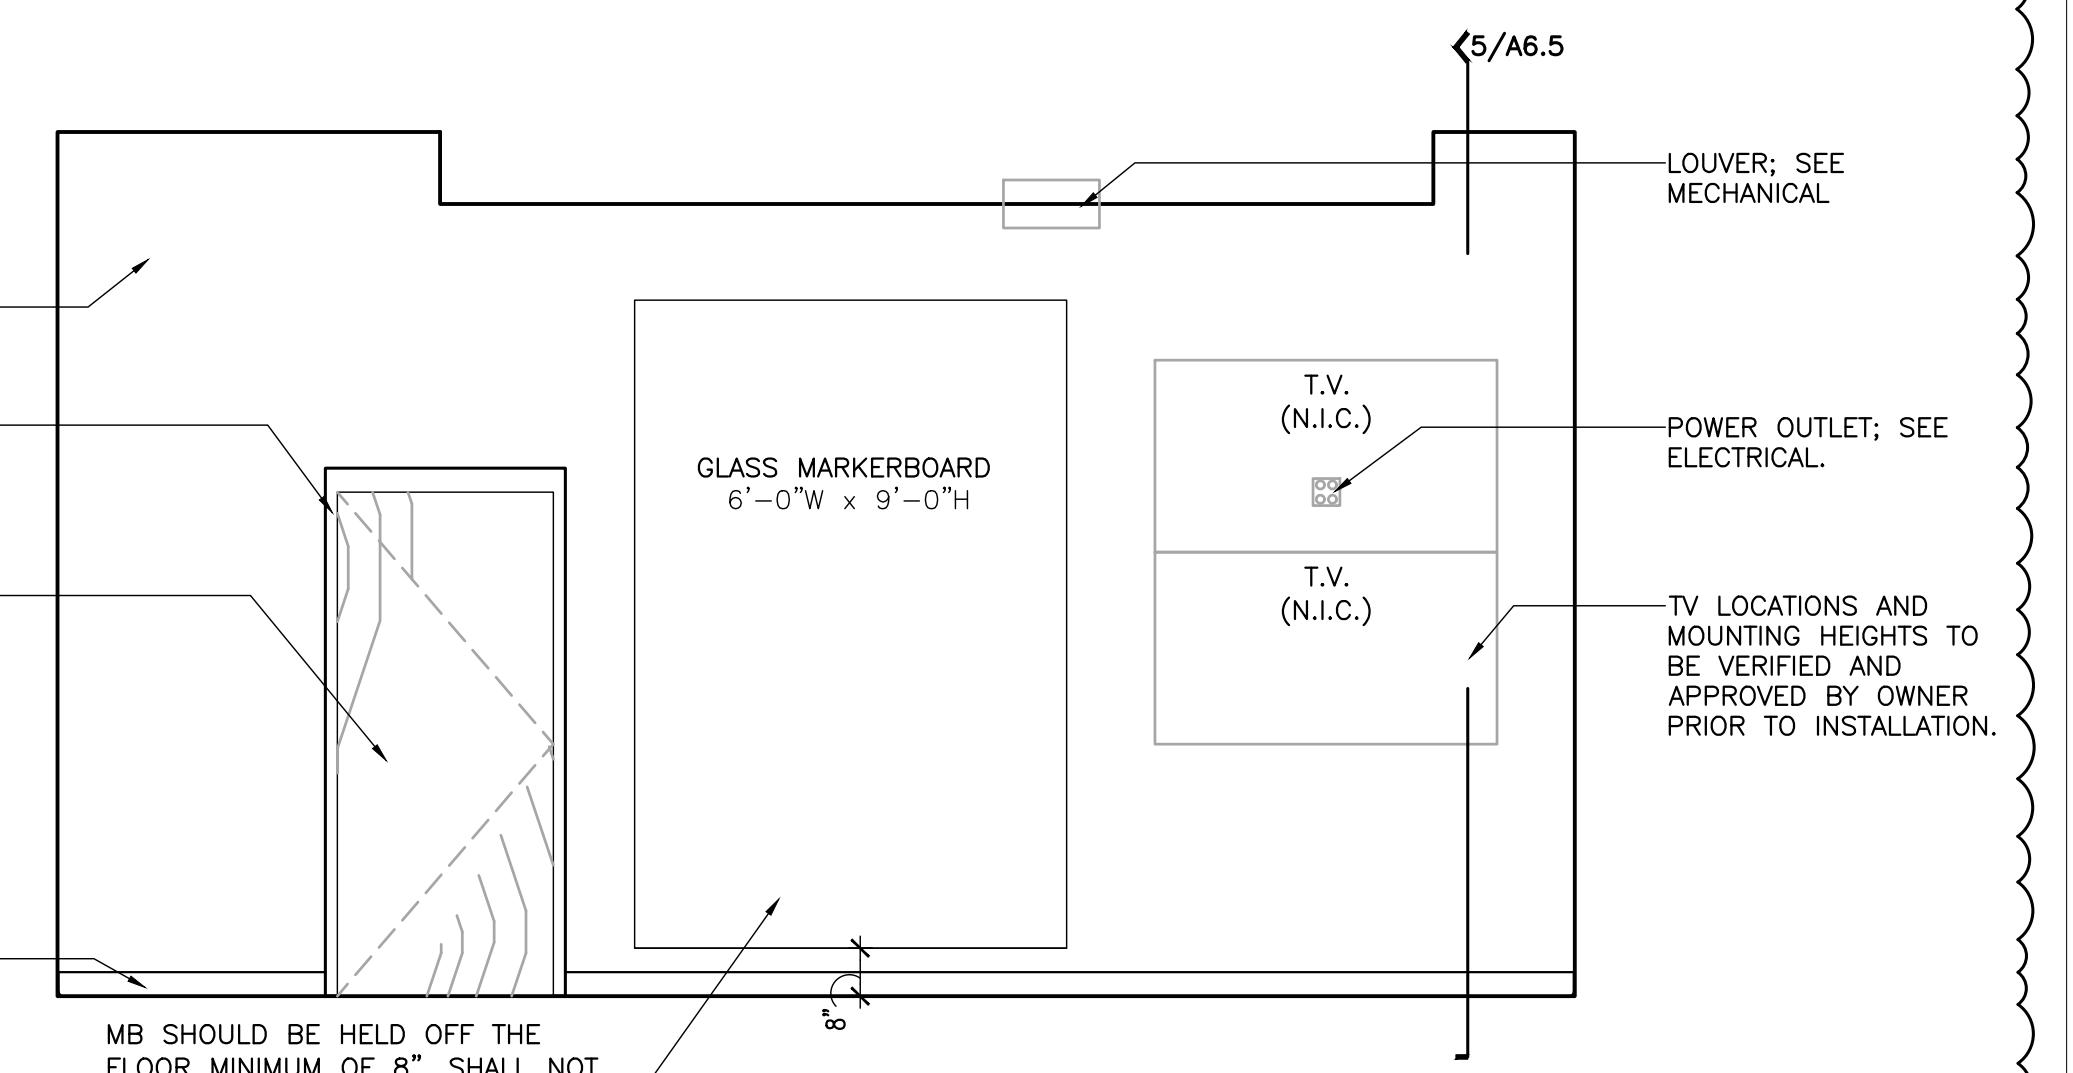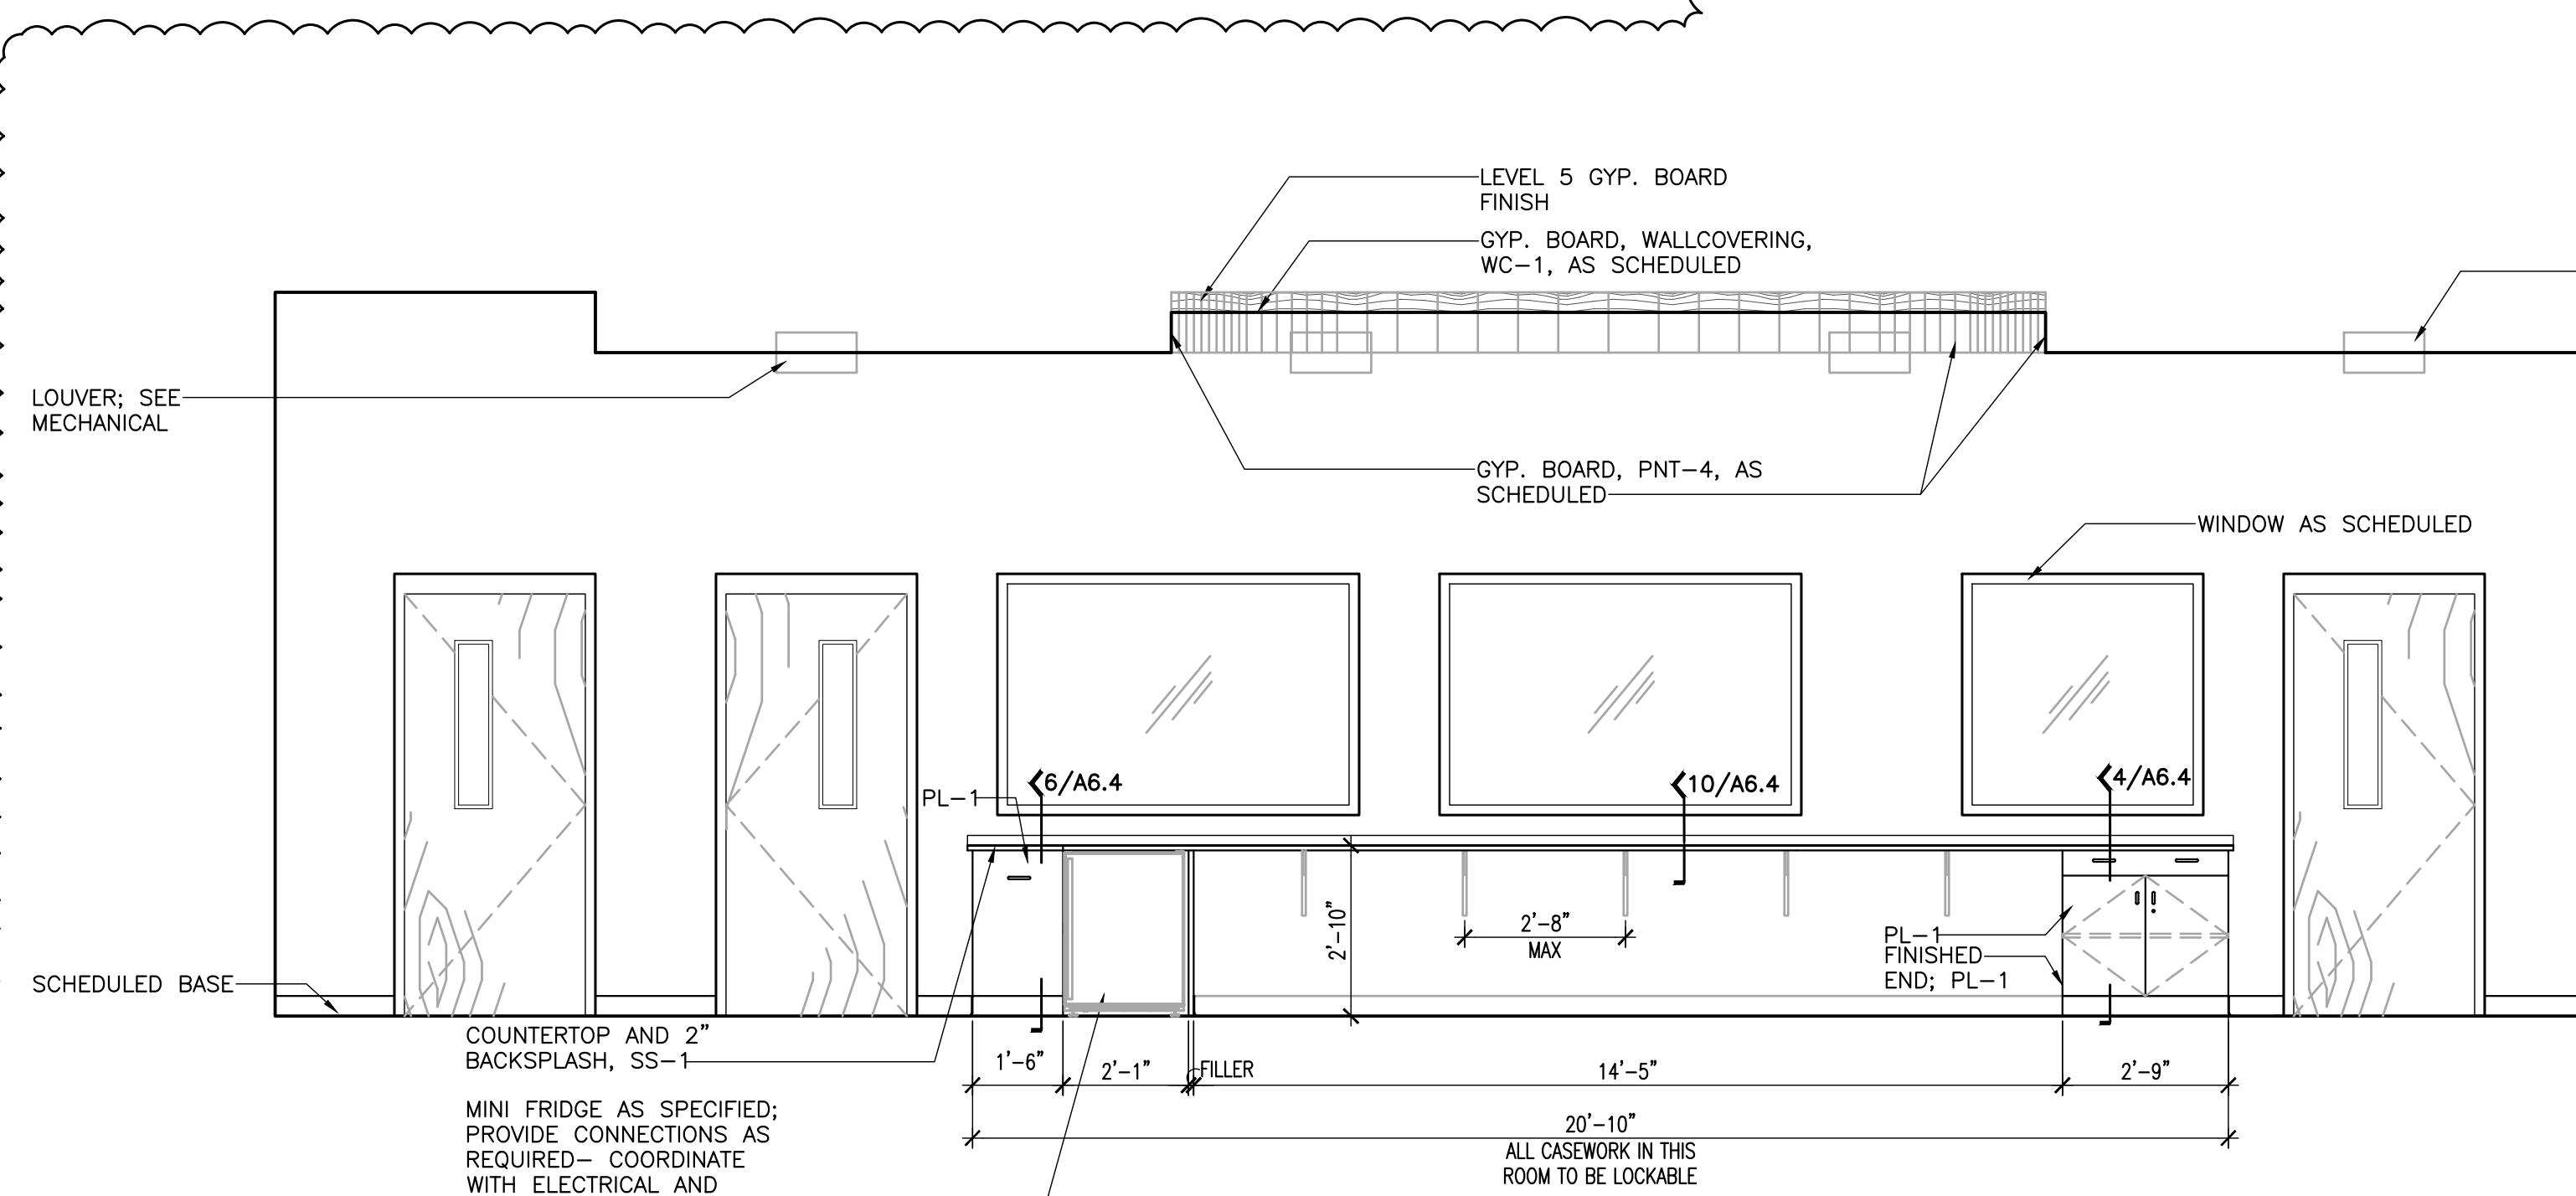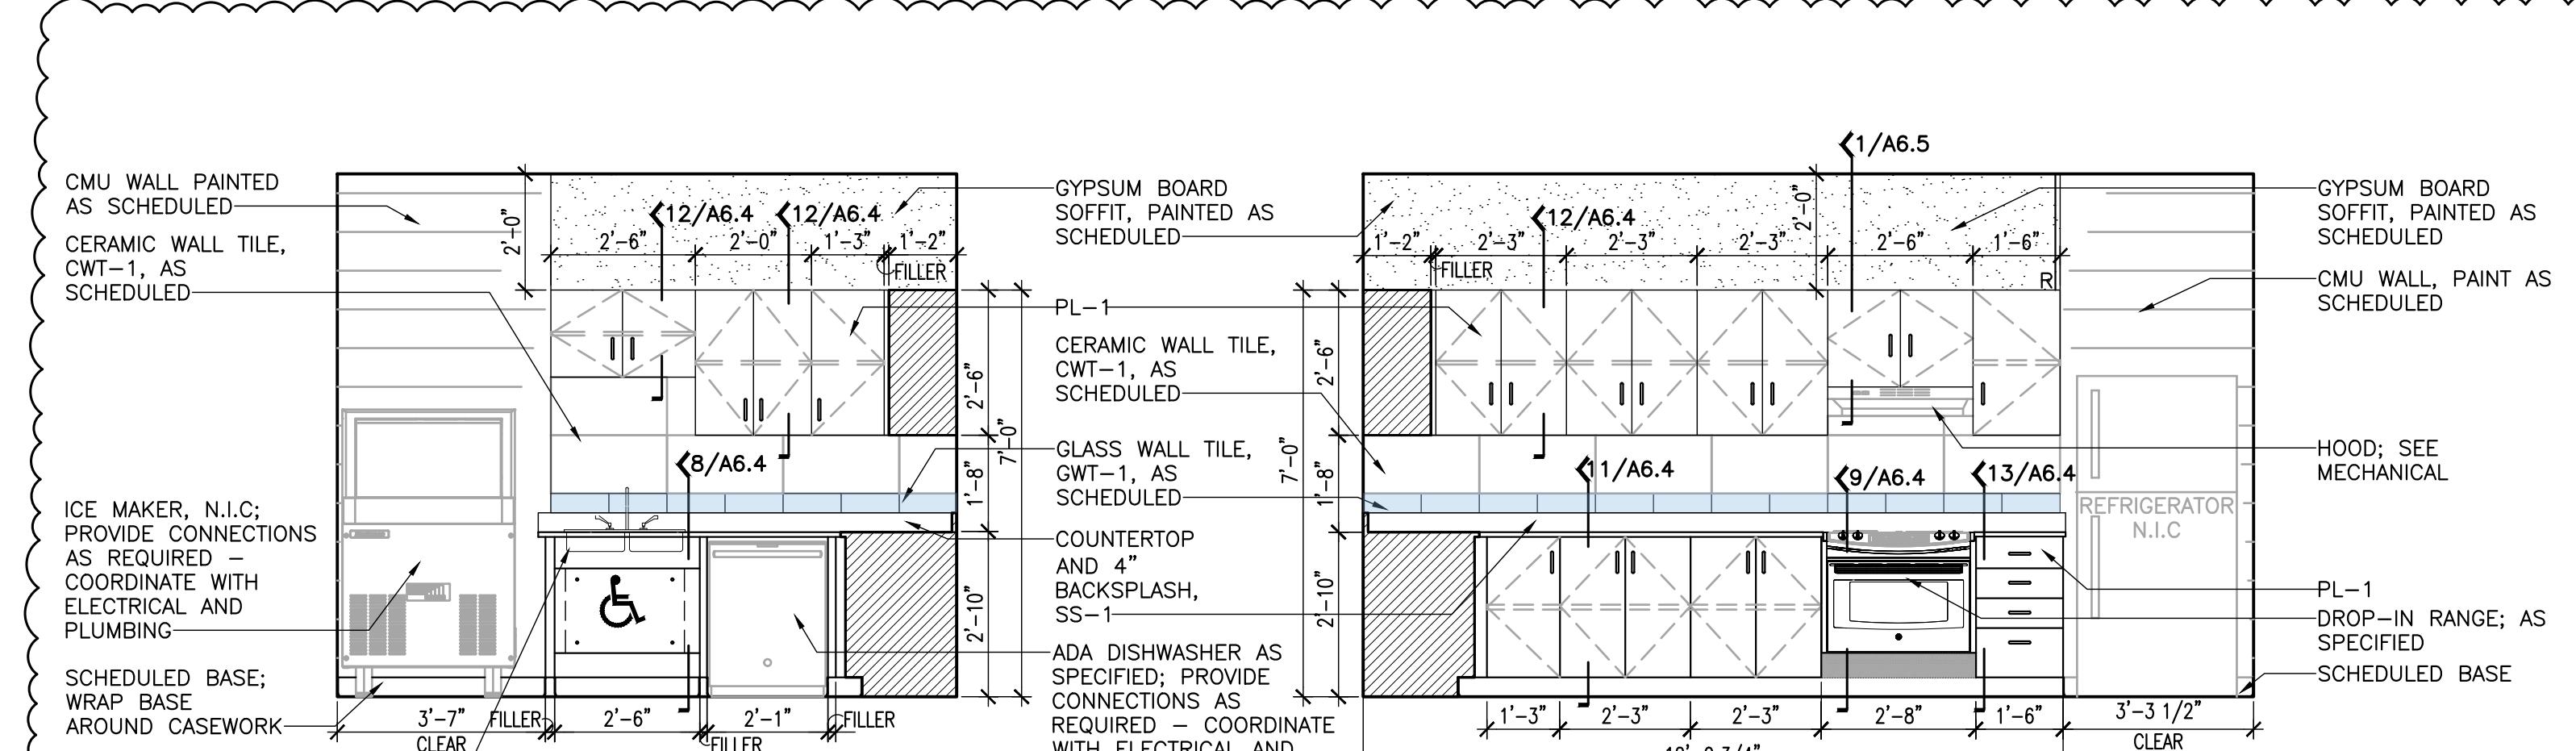

SHEET TITLE:
INTERIOR ELEVATIONS

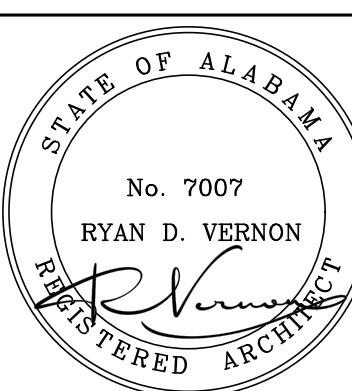


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DRAWN: LKB
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REVISIONS
1 11.18.25 ADD #2


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A6.2


16 OF 24

0 1" 2"




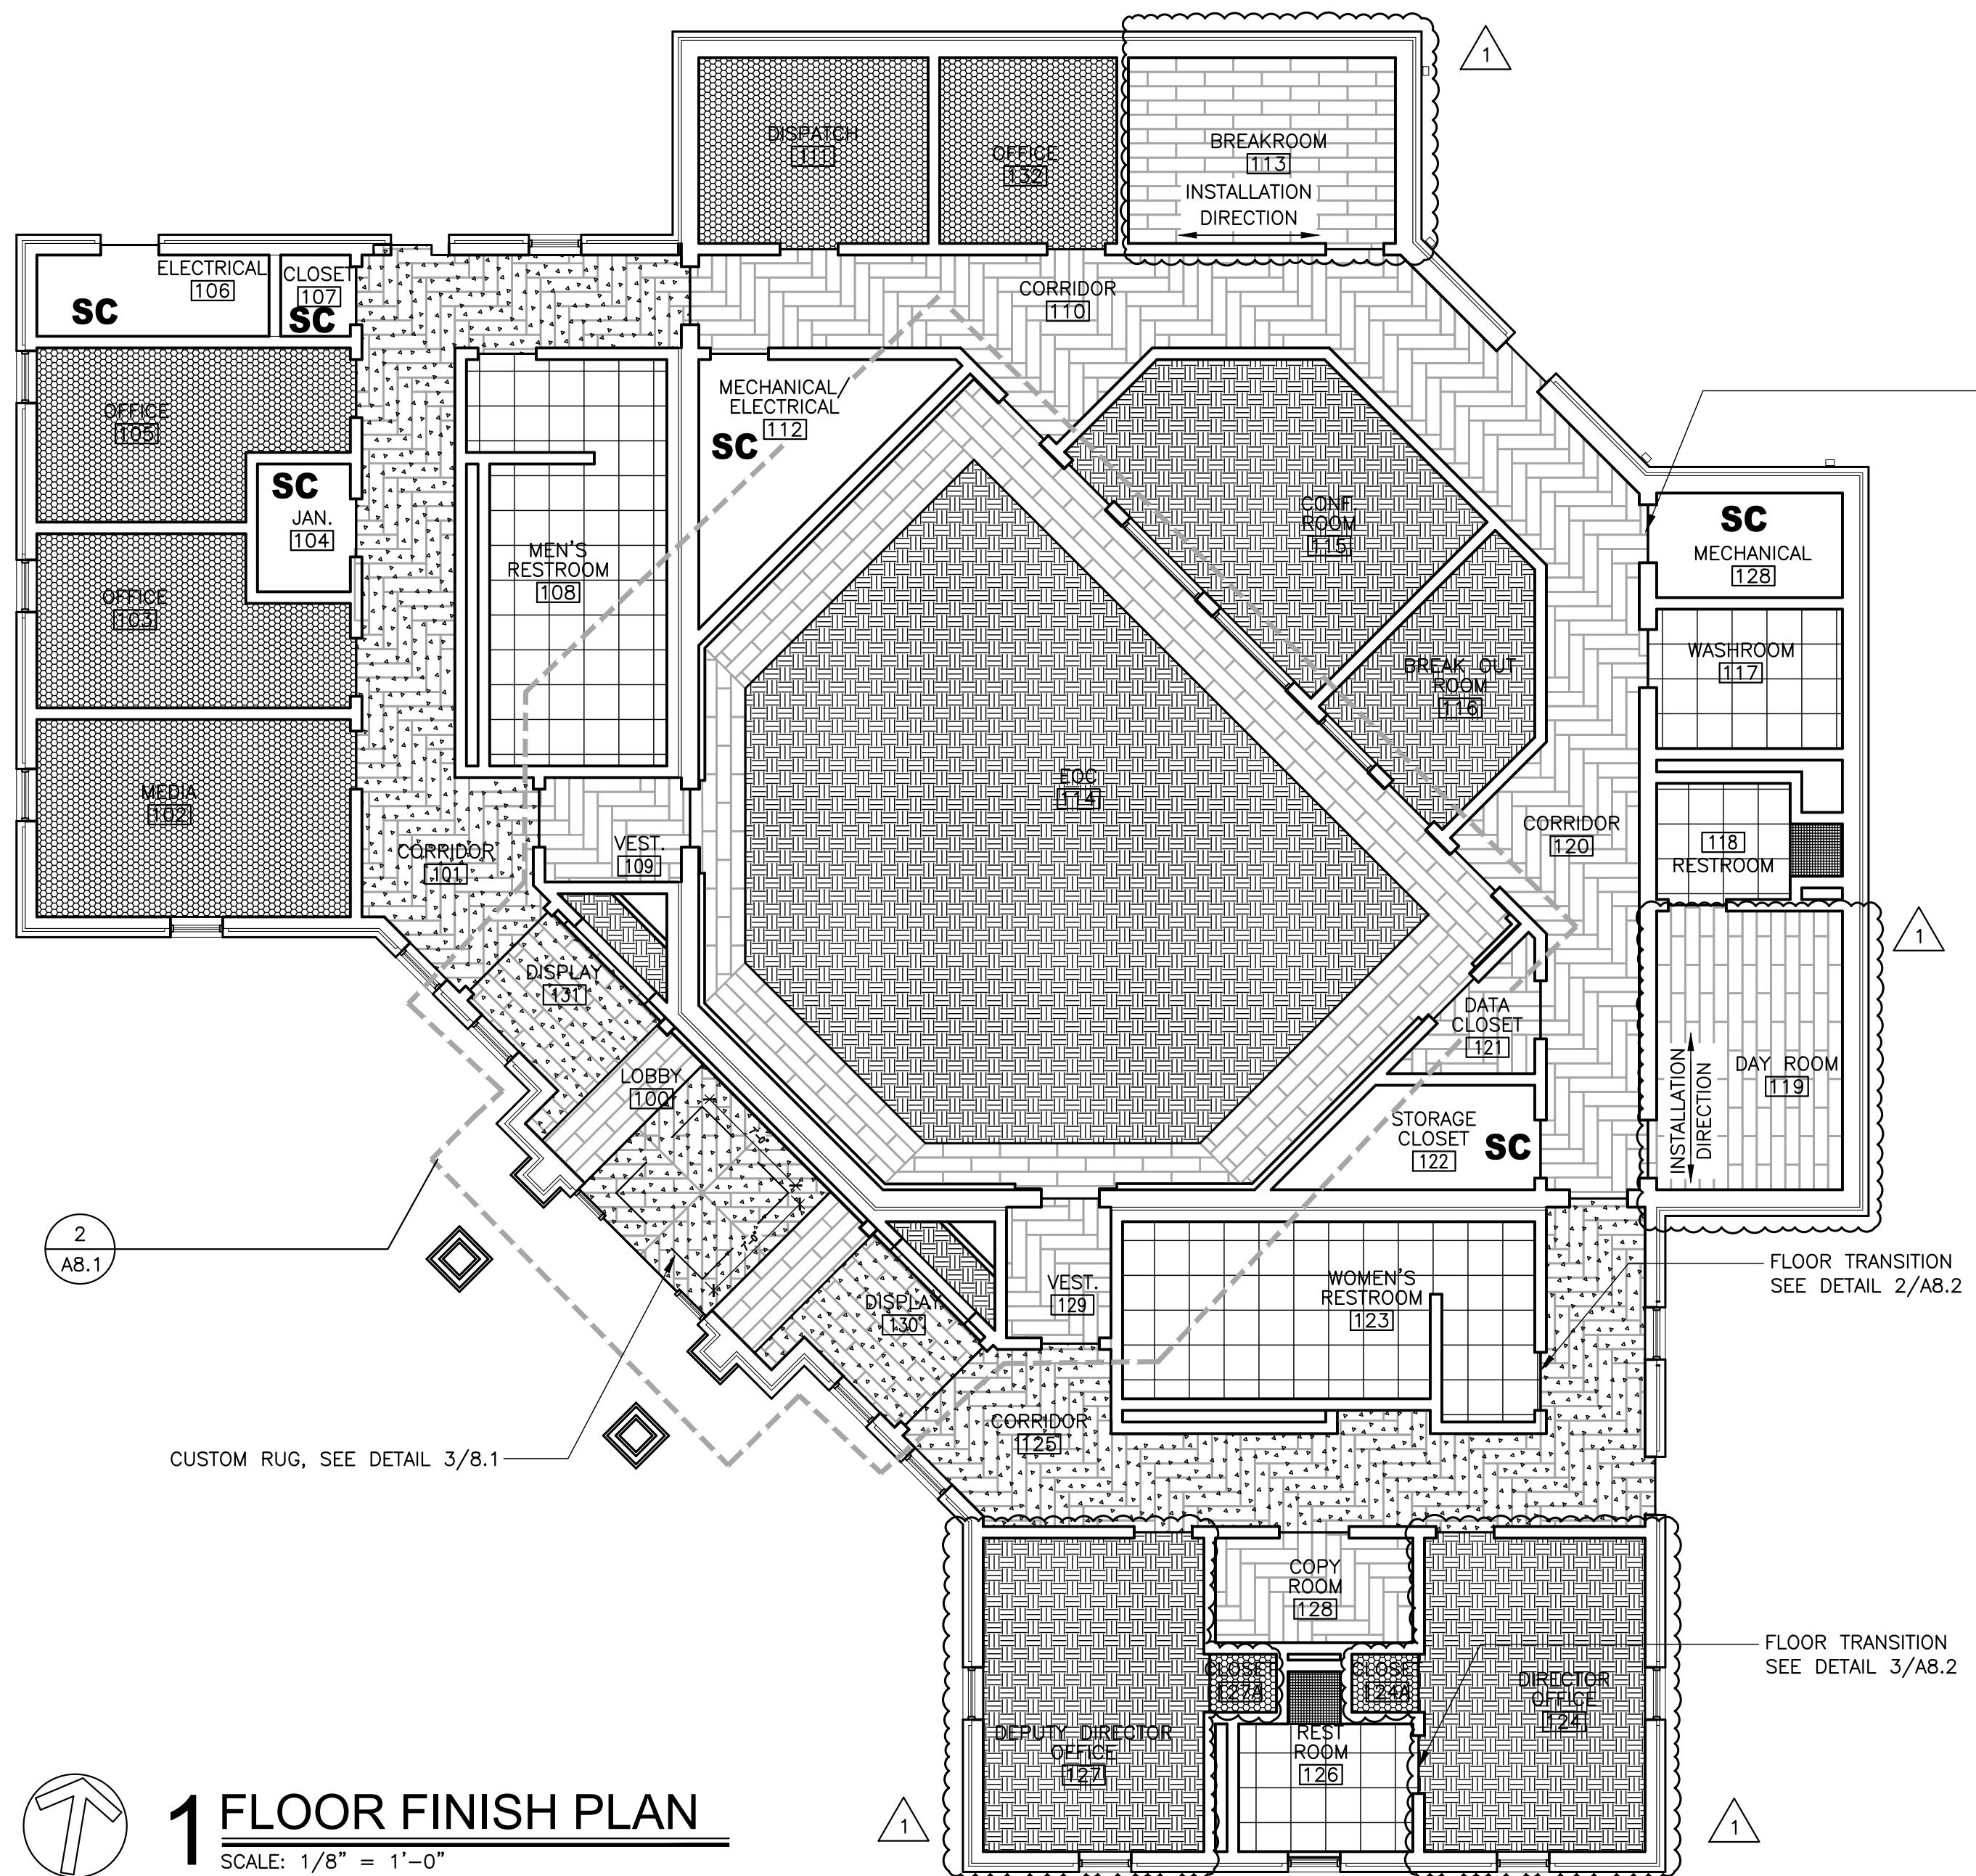

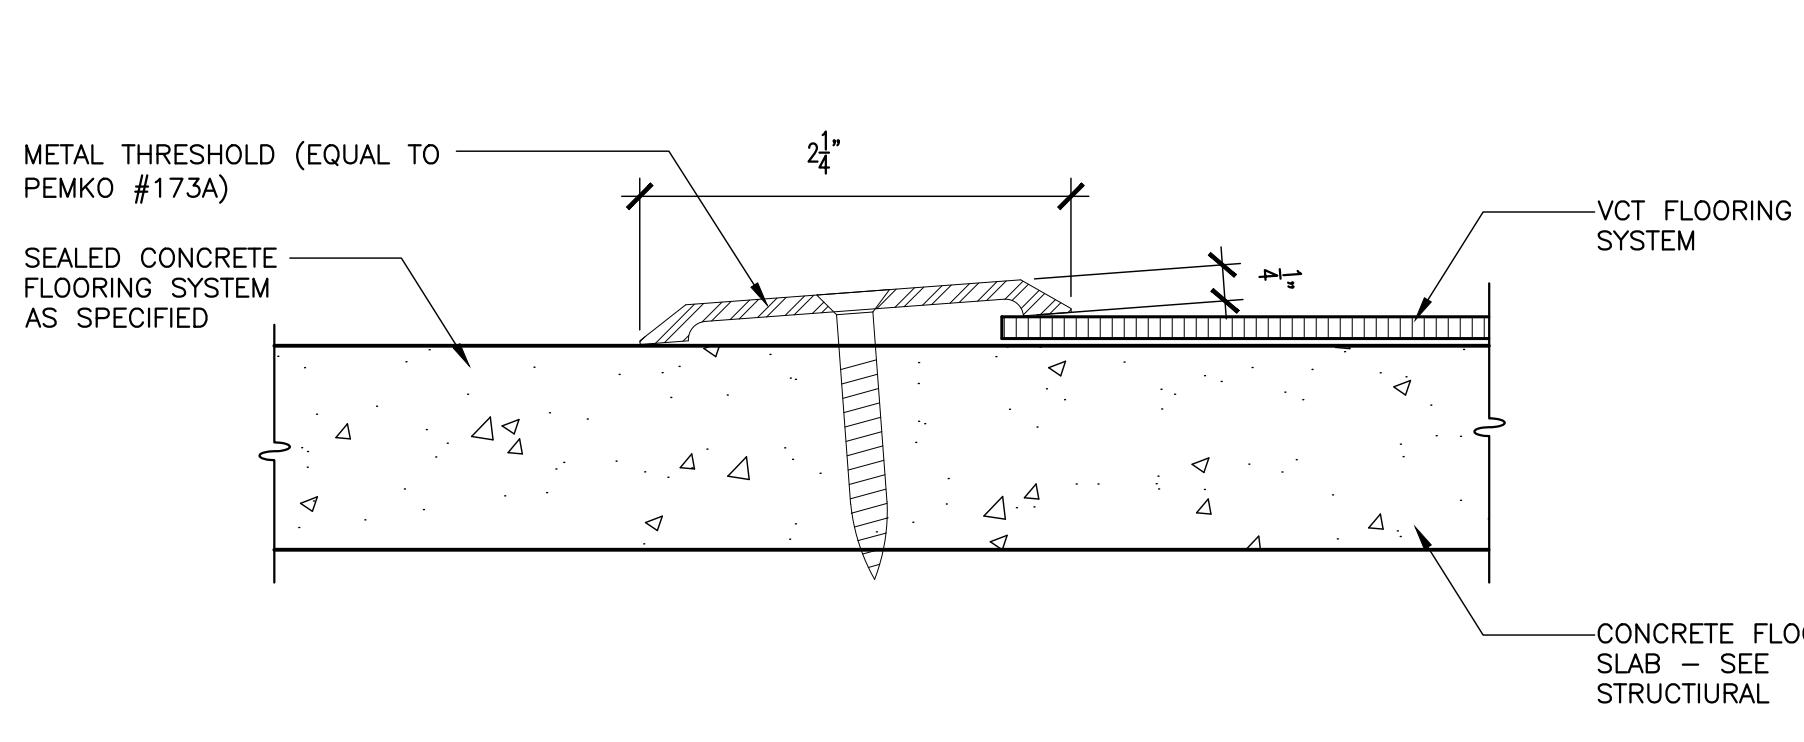1 TRANSITION DETAIL NOT TO SCALE

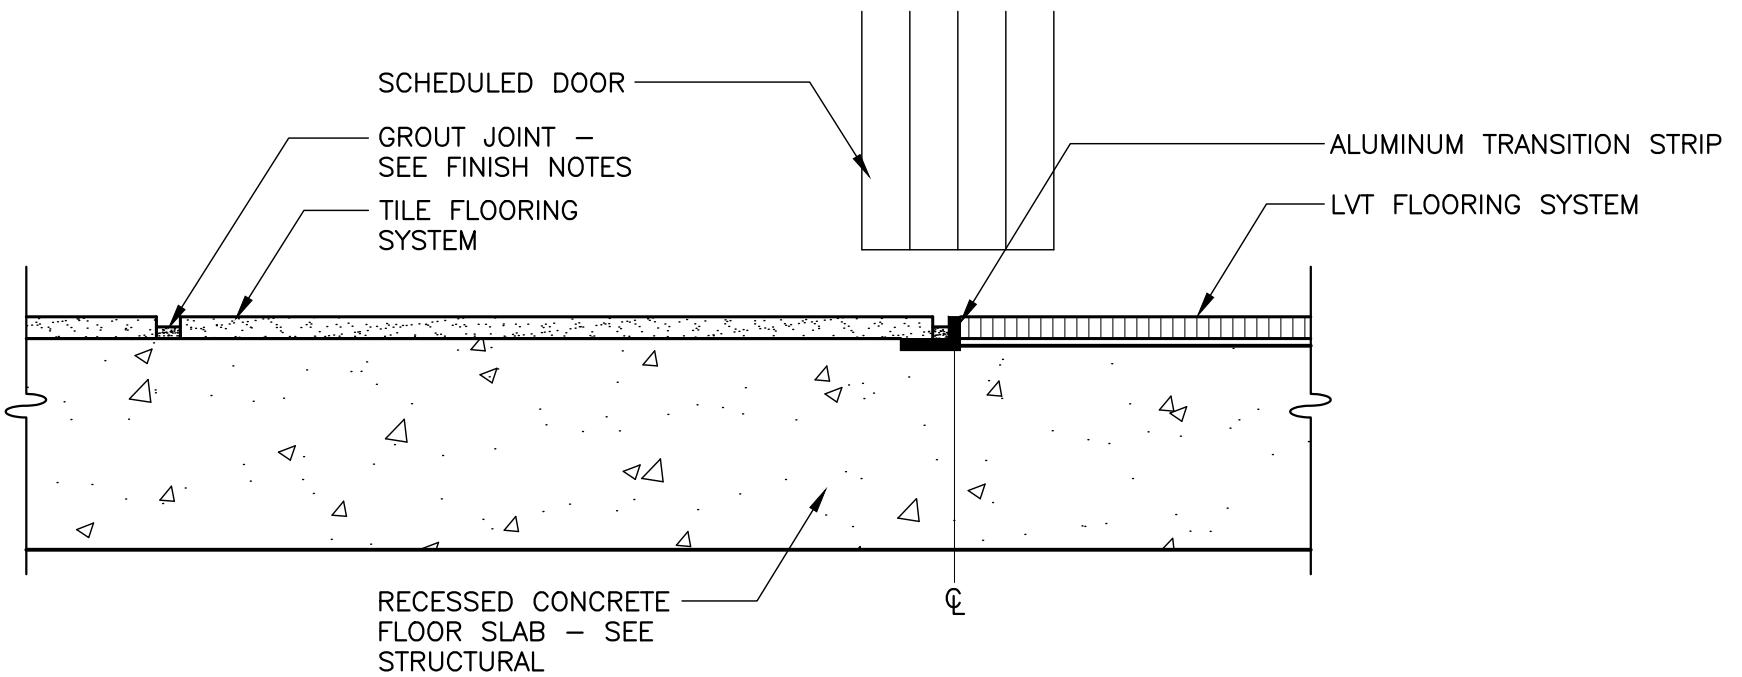

2 TRANSITION DETAIL NOT TO SCALE

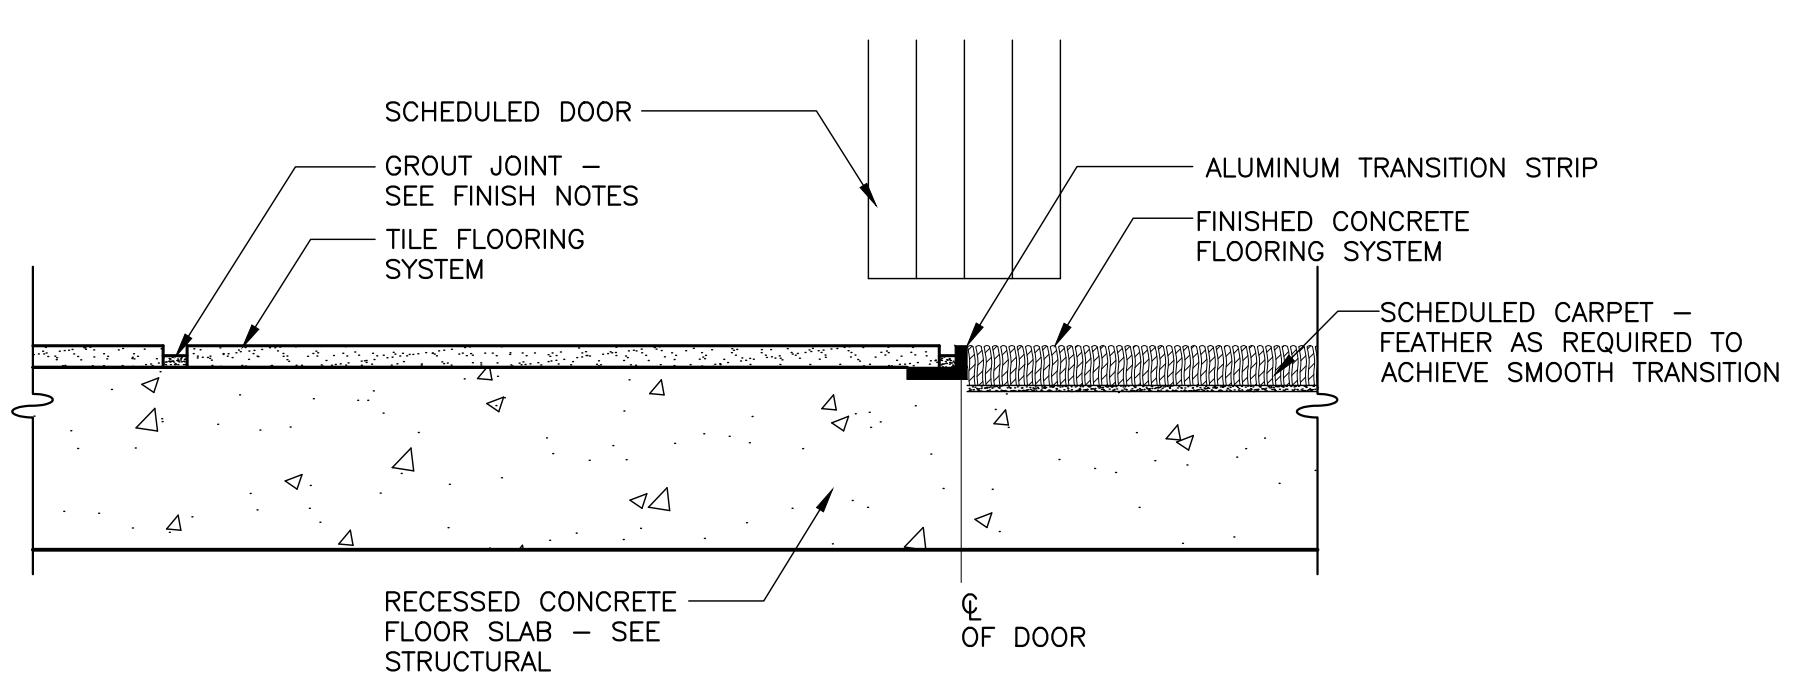

3 TRANSITION DETAIL NOT TO SCALE

ROOM NO.	ROOM NAME	FLOOR	BASE	MILLWORK FACE/TOP	WALLS				DOOR FRAME	CEILING/SOFFIT PAINT	NOTES
					NORTH	SOUTH	EAST	WEST			
100	LOBBY	LVT-1,2&CPT3,4,5,6,7,8	RB-1	-	PNT-1/PNT-4/WC-1	PNT-1	PNT-1	PNT-1	PNT-2	PNT-3/WC-1	CPT-3-8 CUSTOM RUG 1
101	CORRIDOR	LVT-1	RB-1	-	PNT-1	PNT-1	PNT-1	PNT-1	PNT-2		
102	MEDIA	CPT-2	RB-2	-	PNT-1	PNT-1	PNT-1	PNT-1	PNT-2		
103	OFFICE	CPT-2	RB-2	-	PNT-1	PNT-1	PNT-1	PNT-1	PNT-2		
104	JAN.	SC	RB-2	PL-1	PL-1	PNT-1	PNT-1	PNT-1	PNT-2		EPOXY PAINT ON ALL WALLS
105	OFFICE	CPT-2	RB-2	-	PNT-1	PNT-1	PNT-1	PNT-1	PNT-2		
106	ELECTRICAL	SC	RB-2	-	PNT-1	PNT-1	PNT-1	PNT-1	PNT-2		
107	CLOSET	LVT-1	RB-2	PL-1	PL-1	PNT-1	PNT-1	PNT-1	PNT-2		
108	MENS RESTROOM	PFT-1	CTB-1	-	CWT-1/CWT-2/GHT-1	CWT-1/CWT-2/GHT-1	CWT-1/CWT-2/GHT-1	CWT-1/CWT-2/GHT-1	PNT-2		EPOXY PAINT ON ALL WALLS
109	VESTIBULE	LVT-1	RB-2	-	PNT-1	PNT-1	PNT-1	PNT-1	PNT-2		
110	CORRIDOR	LVT-2	RB-2	-	PNT-1	PNT-1	PNT-1	PNT-1	PNT-2		
111	DISPATCH	CPT-2	RB-2	PL-1	PL-1	PNT-1	PNT-1	PNT-1	PNT-2		
112	MECHANICAL/ELECTRICAL	SC	RB-2	-	PNT-1	PNT-1	PNT-1	PNT-1	PNT-2		
113	BREAK ROOM	LVT-2	RB-2	PL-1	SS-1	PNT-1/CWT-1/GWT-1	PNT-1/CWT-1/GWT-1	PNT-1/CWT-1/GWT-1	PNT-2		
114	EOC	LVT-2 & CPT-1	RB-2	PL-1	SS-1	PNT-1	WC-1	PNT-1/WC-1	PNT-2	PNT-3/PNT-4/WC-1	
115	CONFERENCE ROOM	CPT-1	RB-2	-	PNT-1	PNT-1	PNT-1	PNT-1	PNT-2		
116	BREAKOUT ROOM	CPT-1	RB-2	-	PNT-1	PNT-1	PNT-1	PNT-1	PNT-2		
117	WASHROOM	PFT-1	CTB-1	PL-1	PL-1	PNT-1	PNT-1	PNT-1	PNT-2		EPOXY PAINT ON ALL WALLS
118	RESTROOM	PFT-1/PFT-2	CTB-1	-	CWT-1/CWT-2/GWT-1	CWT-1/GWT-1	CWT-1/GWT-1/GWT-2	CWT-1/GWT-1	PNT-2		EPOXY PAINT ON ALL WALLS
119	DAY ROOM	LVT-2	RB-2	PL-1	PL-1	PNT-1	PNT-1	PNT-1	PNT-2		
120	CORRIDOR	LVT-2	RB-2	-	PNT-1	PNT-1	PNT-1	PNT-1	PNT-2		
121	DATA CLOSET	LVT-2	RB-2	-	PNT-1	PNT-1	PNT-1	PNT-1	PNT-2		
122	STORAGE CLOSET	SC	RB-2	PL-1	PL-1	PNT-1	PNT-1	PNT-1	PNT-2		
123	WOMEN'S RESTROOM	PFT-1	CTB-1	-	PNT-1	CWT-1/CWT-2/GHT-1	CWT-1/CWT-2/GHT-1	CWT-1/CWT-2/GHT-1	PNT-2		EPOXY PAINT ON ALL WALLS
124	DIRECTOR OFFICE	CPT-1	RB-2	-	PNT-1	PNT-1	PNT-1	PNT-1	PNT-2		
124A	CLOSET	CPT-1	RB-2	PL-1	PL-1	PNT-1	PNT-1	PNT-1	PNT-2		
125	CORRIDOR	LVT-1	RB-1	-	PNT-1/PWT-1/GWT-1	PNT-1	PNT-1	PNT-1	PNT-2		
126	RESTROOM	PFT-1/PFT-2	CTB-1	-	CWT-1/CWT-2/GWT-1/GHT-1	CWT-1/GWT-1	CWT-1/GWT-1	CWT-1/CWT-2/GWT-1	PNT-2		EPOXY PAINT ON ALL WALLS
127	DEPUTY DIRECTOR OFFICE	CPT-1	RB-2	-	PNT-1	PNT-1	PNT-1	PNT-1	PNT-2		
127A	CLOSET	CPT-1	RB-2	PL-1	PL-1	PNT-1	PNT-1	PNT-1	PNT-2		
128	COPY ROOM	LVT-1	RB-2	PL-1	PL-1	PNT-1	PNT-1	PNT-1	PNT-2		
129	VESTIBULE	LVT-1	RB-2	-	PNT-1	PNT-1	PNT-1	PNT-1	PNT-2		
130	DISPLAY	CPT-1	RB-2	-	PNT-1	PNT-1	PNT-1	PNT-1	PNT-2		
131	DISPLAY	CPT-1	RB-2	-	PNT-1	PNT-1	PNT-1	PNT-1	PNT-2		
132	OFFICE	CPT-2	RB-2	-	PNT-1	PNT-1	PNT-1	PNT-1	PNT-2		

BASE (RUBBER/EPOXY/PORCELAIN)				PAINT			
ITEM	MANUFACTURER	ITEM NUMBER/NAME	LOCATION	ITEM	MANUFACTURER	ITEM NUMBER/NAME	TYPE/LOCATION
RB-1	JOHNSONITE	6" MILLWORK WALL BASE SYSTEM PROFILE: RECESSED MW-XX-X63 COLOR: 63 BRUNT UMBER B	SEE FINISH SCHEDULE	PNT-1	SHERWIN WILLIAMS	COLOR: AGREEABLE GRAY SW7029	GENERAL WALLS
RB-2	JOHNSONITE	4" BURKE BASE COLOR: 63 BRUNT UMBER B	SEE FINISH SCHEDULE	PNT-2	SHERWIN WILLIAMS	COLOR: DORIAN GRAY SW7017	GENERAL TRIM
CBT-1	DALTILE	4"X12" BULLNOSE COLOR: ARCTIC WHITE	SEE FINISH SCHEDULE	PNT-3	SHERWIN WILLIAMS	COLOR: CEILING BRIGHT WHITE	GENERAL CEILING AND SOFFIT
CBT-2	DALTILE	4"X12" BULLNOSE COLOR: (BLUE)	SEE FINISH SCHEDULE	PNT-4	SHERWIN WILLIAMS	COLOR: (BLUE)	ACCENT
PLASTIC LAMINATE				LUXURY VINYL TILE			
ITEM	MANUFACTURER	ITEM NUMBER/NAME	LOCATION	ITEM	MANUFACTURER	ITEM NUMBER/NAME	TYPE/LOCATION
LVT-1	INTERFACE	COLLECTION: LEVEL SET STYLE: NATURAL WOODGRAINS COLOR: WASHED WHEAT A02027 SIZE: 25CM X 1M	SEE FINISH FLOOR PLAN	PL-1	STEVENSWOOD	COLOR: G86 GREGIO NOTTE EDGEBAND: INCLUDED	HORIZONTAL SURFACES: 11 SOFTTEX FINISH VERTICAL SURFACES: 10 ARTKA FINISH
SOLID SURFACE				SS-1	BPI DURASEIN	COLOR: BLOSSOMING	SEE FINISH SCHEDULE
ITEM	MANUFACTURER	ITEM NUMBER/NAME	LOCATION	TACKABLE SURFACE			
LVT-2	INTERFACE	COLLECTION: LEVEL SET STYLE: NATURAL WOODGRAINS COLOR: STORM A02025 SIZE: 25CM X 1M	SEE FINISH FLOOR PLAN	TS-1	KORESEAL	COLOR: EARTHEN 08	SEE FINISH SCHEDULE
CERAMIC TILE				CONCRETE FLOORING			
ITEM	MANUFACTURER	ITEM NUMBER/NAME	LOCATION	ITEM	MANUFACTURER	ITEM NUMBER/NAME	LOCATION
CWT-1	DALTILE	COLLECTION: LUMINIQUE STYLE: FLAT COLOR: ARCTIC WHITE 0190 SIZE: 12X24	MENS RESTROOM 108, RESTROOM 118, WOMENS RESTROOM 123, RESTROOM 126	CWT-2	DALTILE	COLLECTION: COLOR WHEEL UNT: 1 COLOR: ARCTIC WHITE 0190 SIZE: 4X12	MENS RESTROOM 108, BREAK ROOM 113, RESTROOM 118, WOMENS RESTROOM 123, AND RESTROOM 126
GLASS TILE				WALLCOVERING			
ITEM	MANUFACTURER	ITEM NUMBER/NAME	LOCATION	ITEM	MANUFACTURER	ITEM NUMBER/NAME	LOCATION
GWT-1	CREATIVE MATERIALS CORPORATION	COLLECTION: FACETS COLOR: MEDIUM BLUE SIZE: 4X12	MENS RESTROOM 108, BREAK ROOM 113, RESTROOM 118, WOMENS RESTROOM 123, AND RESTROOM 126	WC-1	KORESEAL	COLLECTION: REATEC ARCHITECTURAL FILM STYLE: OAK STRAIGHT GRAIN 11 COLOR: RW-5622	LOBBY 100 AND EOC 114
PORCELAIN FLOOR TILE				FIBERGLASS REINFORCED PANEL			
ITEM	MANUFACTURER	ITEM NUMBER/NAME	LOCATION	ITEM	MANUFACTURER	ITEM NUMBER/NAME	LOCATION
PFT-1	DALTILE	COLLECTION: BRYNE COLOR: COASTLINE BR30 SIZE: 24X24	MENS RESTROOM 108, RESTROOM 117, RESTROOM 118, WOMENS RESTROOM 123, AND RESTROOM 126	FRP-1	KEMLITE COMPANY INC.	COLOR: WHITE SIZE: 4' X 9'	LOBBY 100 AND EOC 114
PFT-2	DALTILE	COLLECTION: BRYNE COLOR: COASTLINE BR30 SIZE: 2X2	SHOWER FLOOR; RESTROOM 118, AND RESTROOM 126	CARPET			
ITEM	MANUFACTURER	ITEM NUMBER/NAME	LOCATION	ITEM	MANUFACTURER	ITEM NUMBER/NAME	LOCATION
CPT-1	INTERFACE	COLLECTION: NIGHT LIGHTS STYLE: SOFT GLOW COLOR: 107262 IRON AZURE SIZE: 25CM X 50CM INSTALLATION DIRECTION: ASHLAR	ECC 114, CONF. ROOM 115, BREAKOUT ROOM 116, DISPLAY 130, AND DISPLAY 131	CPT-2	INTERFACE	COLLECTION: DRESSED LINES STYLE: COMES AROUND COLOR: 108516 CHARCOAL SIZE: 25CM X 50CM INSTALLATION DIRECTION: ASHLAR	MEDIA 102, OFFICE 103, OFFICE 105, DISPATCH 111, DIRECTOR OFFICE 124, CLOSET 124A, DEPUTY DIRECTOR OFFICE 127, CLOSET 127A, AND OFFICE 132
CPT-3	INTERFACE	COLLECTION: VVA COLORES COLOR: 101171 CANO SIZE: 50CM X 50CM	LOBBY 100	CPT-4	INTERFACE	COLLECTION: VVA COLORES COLOR: 101147 AZUL SIZE: 50CM X 50CM	LOBBY 100
CPT							